




# FRANCIS QUADRANGLE - IRRIGATION, DRAINAGE, AND TURF REPLACEMENT

## FOR THE CURATORS OF THE UNIVERSITY OF MISSOURI PROJECT NO. CP241991

### LOCATION MAP

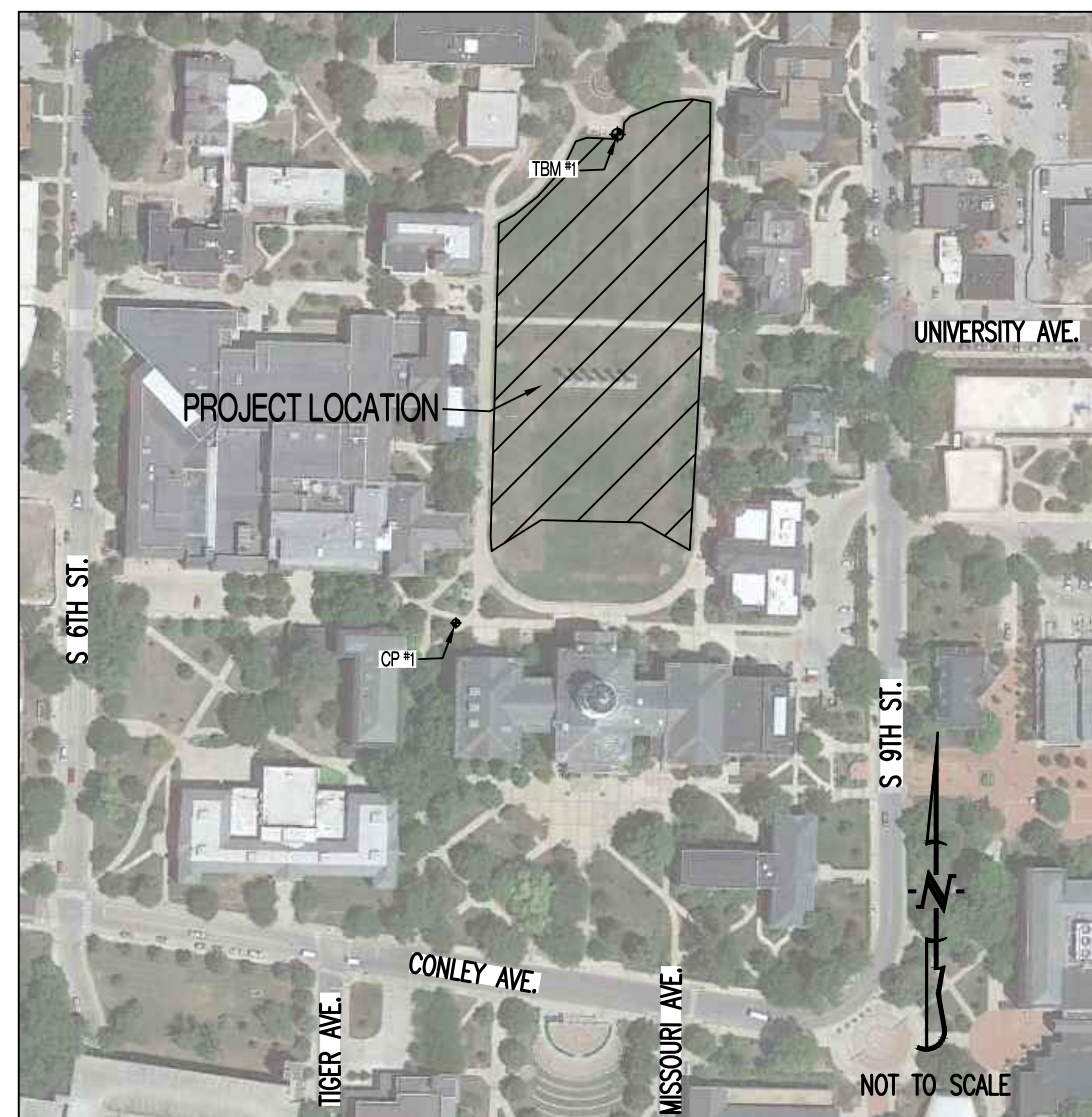

### GENERAL NOTES:

EXISTING UNDERGROUND UTILITIES HAVE BEEN PLOTTED FROM EXISTING RECORDS AND THEIR LOCATIONS ARE APPROXIMATE ONLY. OTHER UTILITIES OR OBSTRUCTIONS MAY ALSO BE ENCOUNTERED. IT SHALL BE THE CONTRACTORS RESPONSIBILITY TO DETERMINE THE EXACT LOCATION OF ALL EXISTING UNDERGROUND UTILITIES AND TO AVOID DAMAGE TO SAME DURING CONSTRUCTION. IF IT CAN BE DETERMINED BY THE OWNER'S REPRESENTATIVE THAT ANY EXISTING UTILITY HAS BEEN, OR CAN BE ABANDONED, CONTRACTOR SHALL REMOVE SAME, AT HIS EXPENSE, TO FACILITATE CONSTRUCTION. ENDS OF REMAINING CONDUITS OR PIPES SHALL BE PLUGGED OR CAPPED.

EXISTING UTILITIES SHOWN FOR REFERENCE ONLY. FIELD VERIFY UTILITY LOCATIONS, ELEVATIONS, AND SLOPES PRIOR TO CONSTRUCTING NEW UTILITIES.

SUPPORT AND PROTECT UTILITIES CROSSING EXCAVATIONS. RESTORE DAMAGED UTILITIES TO ORIGINAL CONDITIONS PRIOR TO BACKFILLING EXCAVATIONS. OBTAIN INSPECTION AND APPROVAL OF OWNER'S REPRESENTATIVE PRIOR TO BACKFILLING EXCAVATIONS.

DO NOT STORE EQUIPMENT OR MATERIAL IN AREA OF TREES. PROTECT TREES FROM DAMAGE UNLESS NOTED OTHERWISE. OWNER WILL TRIM TREES AS REQUIRED PRIOR TO CONSTRUCTION. COORDINATE WITH OWNER'S REPRESENTATIVE.

INSTALL CONSTRUCTION FENCING AROUND THE DRIP LINES OF ALL TREES IN WORK AREAS.

COORDINATE CONSTRUCTION FENCE LOCATION WITH OWNER'S REPRESENTATIVE PRIOR TO PROCEEDING.

REPLACE ALL PAVING, SIDEWALKS, CURBS, GUTTERS, DRAINAGE STRUCTURES, PAVEMENT MARKING, SIGNS, PARKING METERS, LIGHTS, BIKE RACKS, ETC. REMOVED OR DAMAGED DURING CONSTRUCTION. COMPLY WITH CITY OF COLUMBIA OR MU STANDARDS, AS APPROPRIATE. CONTRACTOR TO PROTECT ALL EXISTING UTILITIES, STRUCTURES, AND PAVEMENT THAT IS TO REMAIN. ALL DAMAGED ITEMS OUTSIDE THE SCOPE OF WORK TO ARE TO BE REPLACED OR REPAIRED TO ORIGINAL CONDITION AT THE CONTRACTORS EXPENSE.

CONTRACTOR SHALL NOT BLOCK ACCESS TO ANY MANHOLE OR VALVE BOX.

THE STORM WATER POLLUTION PREVENTION MEASURES INDICATED ARE THE MINIMUM MEASURES TO BE USED. PROVIDE ADDITIONAL SITE SPECIFIC MEASURES AS NECESSARY TO PREVENT STORM WATER POLLUTION & TO COMPLY WITH THE REQUIREMENTS OF THE AUTHORITY HAVING JURISDICTION. THE CONTRACTOR IS RESPONSIBLE FOR MAINTAINING ALL EROSION CONTROL DEVICES AND REMOVING THEM ONCE THE SITE IS STABILIZED.

CONTRACTOR SHALL COORDINATE SITE LOGISTICS AMONGST ADJACENT CONCURRENT PROJECTS WITH OWNER'S REPRESENTATIVE.

IT IS THE INTENT OF THESE PLANS TO COMPLY WITH THE REQUIREMENTS OF THE MODNR CLEAN WATER COMMISSION.

ALL PAVEMENTS, SIDEWALKS, ABANDONED SEWERS, PIPELINES, EXCESS EARTHWORK, OR OTHER OBSTRUCTIONS TO CONSTRUCTION THAT ARE REMOVED SHALL BECOME THE PROPERTY OF THE CONTRACTOR UNLESS SPECIFICALLY NOTED AND SHALL BE DISPOSED OF BY THE CONTRACTOR IN ACCORDANCE WITH STATE REGULATION 10 CSR 80-2.010 (9)(A)1.

ALL SLOPES ARE 3:1 OR FLATTER UNLESS OTHERWISE NOTED.

ALL DISTURBED AREAS WITHIN THE "LIMITS OF DISTURBANCE" SHALL BE FINE GRADED BY CONTRACTOR AND VEGETATION REESTABLISHED BY OWNER.

ROOT SYSTEM FROM PREVIOUSLY REMOVED TREES REMAIN AND MAY BE ENCOUNTERED DURING GRADING AND INSTALLATION OF UTILITIES. CONTRACTOR TO REMOVE ROOTS IN TOP 6" OF SOIL TO BE AMENDED. ROOTS DEEPER THAN 6" SHALL REMAIN.

CONTRACTOR SHALL ADJUST ALL YARD BOXES, VALVE BOXES, PULL BOXES, CLEANOUTS, MANHOLE LID RINGS, AND OTHER UTILITY STRUCTURES TO FINISHED GRADE.

REMAINS FROM ACADEMIC HALL (BUILDING DESTROYED BY FIRE IN 1892). MAY BE ENCOUNTERED DURING GRADING. ANY ARTIFACTS FOUND SHALL BE RETURNED TO OWNER.

TOTAL DISTURBED AREA ON SITE = 2.61 AC.

### SHEET LIST TABLE

SHEET NUMBER	SHEET TITLE	CD SET 03/20/24
CE 0	COVER SHEET	X
CE 11	EXISTING CONDITIONS NORTH QUAD	X
CE 12	EXISTING CONDITIONS SOUTH QUAD	X
CE 21	EROSION CONTROL AND SITE ACCESS PLAN	X
L-100	GRADING AND STORM SEWER PLAN	X
L-200	PLANTING PLAN	X
L-201	PLANTING DETAILS AND SPECIFICATIONS	X
L-300	IRRIGATION PLAN - BASE BID	X
L-301	IRRIGATION PLAN - ADD ALTERNATE #1	X
L-302	IRRIGATION DETAILS	X
L-303	IRRIGATION SPECIFICATIONS	X

### PROJECT BENCHMARK:

MCP #005 - 2" DOMED BRONZED CONCRETE SURVEY MARKER LOCATED IN THE SIDEWALK AT THE SOUTHEAST CORNER OF UNIVERSITY AVE. AND HITT ST. INTERSECTION.  
NORTHING - 1133490.99  
EASTING - 1690054.62  
ELEVATION - 764.78

TBM #1 - CHISELED SQUARE LOCATED ON THE SOUTHEASTERN CORNER OF THE CONCRETE PAD APPROXIMATELY 290' NORTH OF THE COLUMNS AND APPROXIMATELY 140' WEST OF REYNOLDS JOURNALISM INSTITUTE.  
ELEVATION = 736.76

### SURVEY CONTROL POINTS:

CP #1 (PK NAIL) - NORTHING: 1133168.41 (FT.)  
EASTING: 1689251.75 (FT.)

### COORDINATE SYSTEM NOTES:

COORDINATES SHOWN ARE MODIFIED MISSOURI STATE PLANE COORDINATES (CENTRAL ZONE). MODIFICATION INCLUDES CONVERSION FOR METERS TO U.S. SURVEY FOOT. USING 3.280833 FEET PER METER.

### ENGINEER CERTIFICATION:

BY SIGNING AND AFFIXING MY SEAL TO THESE PLANS, I HEREBY CERTIFY THAT THESE DRAWINGS AND/OR SPECIFICATIONS HAVE BEEN PREPARED BY ME, OR UNDER MY SUPERVISION. I FURTHER CERTIFY THAT TO THE BEST OF MY KNOWLEDGE THESE DRAWINGS AND/OR SPECIFICATIONS ARE AS REQUIRED BY AND IN COMPLIANCE WITH THE BUILDING CODES OF THE UNIVERSITY OF MISSOURI.

### LEGEND OF SYMBOLS:

(\* indicates utility drawn from map provided by owner)

---	EXISTING CURB	.....744.....	EXISTING MINOR CONTOUR
---	EXISTING WATERLINE	---745---	EXISTING MAJOR CONTOUR
---	EXISTING WATERLINE	○	EXISTING DECIDUOUS TREE
⊗	EXISTING WATER VALVE	⊗	EXISTING CONIFEROUS TREE
⊕	EXISTING WATER METER	⊗	EXISTING LIGHT POLE
⊕	EXISTING FIRE HYDRANT	⊗	EXISTING UTILITY POLE
---	EXISTING GAS LINE	⊗	EXISTING AIR CONDITIONER
⊕	EXISTING GAS METER	⊗	EXISTING TELEPHONE PEDESTAL
---	EXISTING SANITARY SEWER	⊗	EXISTING ELECTRICAL TRANSFORMER
⊕	STORM/SANITARY MANHOLE	⊗	EXISTING ELECTRIC METER
---	EXISTING SANITARY SEWER LATERAL	⊗	EXISTING CONCRETE
---	EXISTING UNDERGROUND ELECTRIC	⊗	EXISTING ASPHALT
---	EXISTING UNDERGROUND FIBER OPTIC	⊗	PROPOSED CONCRETE
---	EXISTING STEAM CHASE	⊗	EXISTING SIGN
⊕	EXISTING STORM SEWER	⊗	EXISTING POST AND CHAIN FENCE
⊕	BEEHIVE INLET	⊗	EXISTING BRICK PAVERS
---	PROPOSED CURB		
⊕	EXISTING STRUCTURE		

### FLOOD PLAIN STATEMENT:

NO PART OF THIS TRACT IS LOCATED WITHIN THE 100-YEAR FLOODPLAIN AS PER THE FEM F.I.R.M. PANEL #29019C0280E DATED APRIL 19, 2017.

### UTILITY COMPANIES:

#### LOCATES:

MISSOURI ONE CALL INC.  
1022 B NORTHEAST DRIVE  
JEFFERSON CITY, MO 65109  
1-800-344-7483



#### WATER/ELECTRIC:

CITY OF COLUMBIA  
P.O. BOX 6015  
WATER & LIGHT DEPARTMENT  
COLUMBIA, MO 65205  
573-874-7325

#### SANITARY SEWER:

CITY OF COLUMBIA  
P.O. BOX 6015  
UTILITIES DEPARTMENT  
COLUMBIA, MO 65205  
573-874-7250

#### WATER/ELECTRIC:

ENERGY MANAGEMENT  
417 S. 5TH ST.  
COLUMBIA, MO 65211  
573-882-3094

#### STORM/SANITARY SEWER & SECONDARY ELECTRIC:

UNIVERSITY CAMPUS FACILITY OPERATIONS  
180 GENERAL SERVICES BUILDING  
COLUMBIA, MO 65211  
573-882-8211

#### NATURAL GAS:

AMEREN MISSOURI  
2001 MAGUIRE BLVD.  
COLUMBIA, MO 65201  
573-876-3030


#### FIBER:

UNIVERSITY OF MISSOURI, DIVISION OF I.T.  
920 S COLLEGE AVE.  
COLUMBIA, MO 65211  
573-882-5000

### REVISIONS:

NO.	DATE
BID SET	03/20/2024

THIS SHEET HAS BEEN SIGNED, SEALED AND DATED ELECTRONICALLY AND

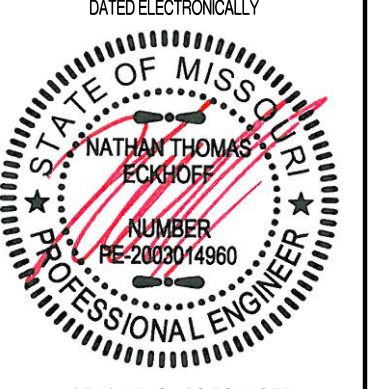

NATHAN THOMAS ECKHOFF  
MO LICENSE: 200304960



OWNER:  
THE CURATORS OF THE UNIVERSITY OF MISSOURI  
2001 UNIVERSITY HALL  
COLUMBIA BUSINESS SERVICES  
COLUMBIA, MO 65211

CP241991 - FRANCIS QUADRANGLE  
IRRIGATION, DRAINAGE, AND TURF REPLACEMENT  
COLUMBIA, BOONE COUNTY, MISSOURI

### DRAWING INCLUDES:

COVER SHEET

DESIGNED: NTE

DRAWN: NMD

PROJECT NO.: CP241991

SHEET:

CE 0



REVISIONS:

NO.	DATE
BID SET	03/20/2024

THIS SHEET HAS BEEN SIGNED, SEALED AND DATED ELECTRONICALLY



NATHAN THOMAS ECKHOFF  
MO LICENSE=200304960

PREPARED BY: **CROCKETT ENGINEERS**  
ENGINEERS AND ARCHITECTS  
1008 W. Illinois Blvd., Ste. 200  
Columbia, Missouri 65203  
(372) 487-0299  
www.crockettengineering.com  
Crockett Engineering Consultants, LLC  
Missouri Certificate of Authority  
#000000001



OWNER:  
THE COURTESY OF THE UNIVERSITY OF MISSOURI  
200 S. AMESSTY HALL  
C/O BUSINESS SERVICES  
COLUMBIA, MO 65211

**CP241991 - FRANCIS QUADRANGLE  
IRRIGATION, DRAINAGE, AND TURF REPLACEMENT**  
COLUMBIA, BOONE COUNTY, MISSOURI

DRAWING INCLUDES:  
EXISTING CONDITIONS NORTH QUAD

DESIGNED: NTE  
DRAWN: NMD  
PROJECT NO.: CP241991  
SHEET: CE.11


Y:\2024\240006 - CP241991 - Francis Quad - Irrigation, Drainage and Turf Replacement\Civil\A000 Files Construction Plans\240006 Site Base.dwg

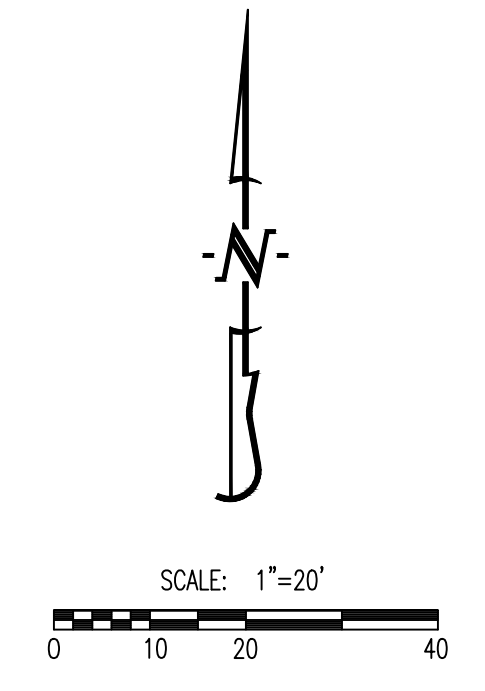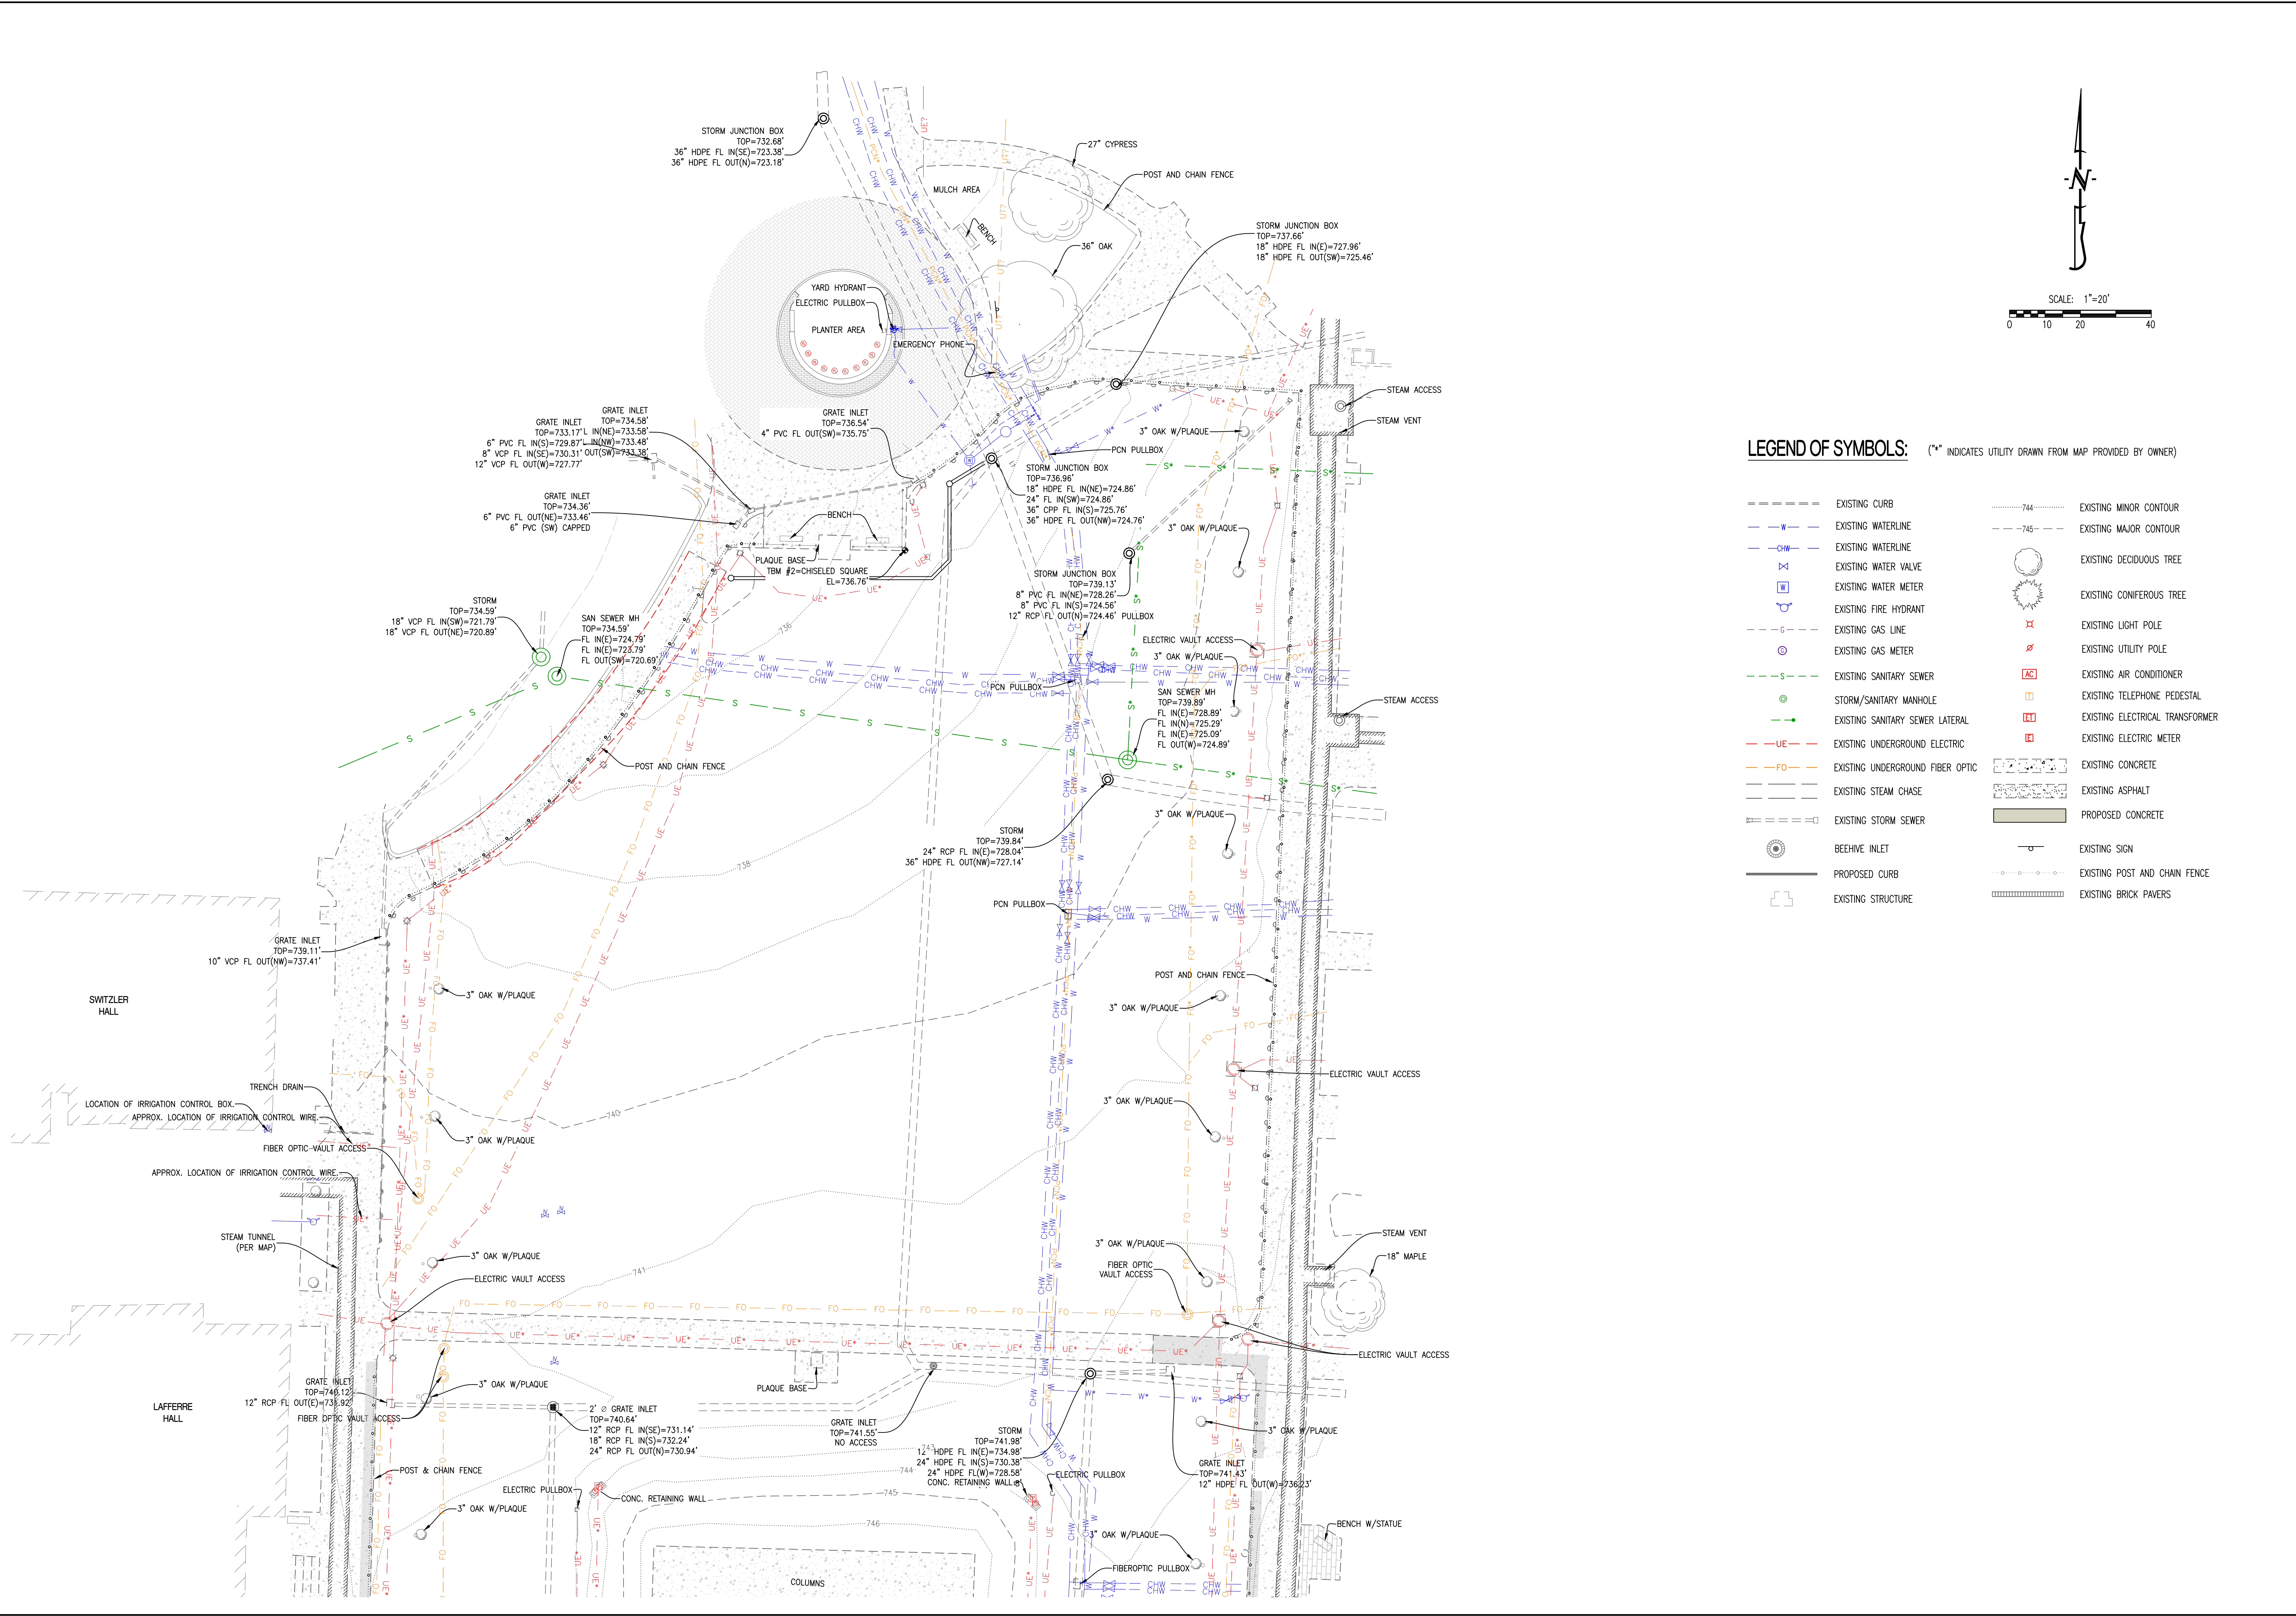

**LEGEND OF SYMBOLS:** (\* INDICATES UTILITY DRAWN FROM MAP PROVIDED BY OWNER)

---	EXISTING CURB	---	EXISTING MINOR CONTOUR
---	EXISTING WATERLINE	---	EXISTING MAJOR CONTOUR
---	EXISTING WATERLINE	---	EXISTING DECIDUOUS TREE
---	EXISTING WATER VALVE	---	EXISTING CONIFEROUS TREE
---	EXISTING WATER METER	---	EXISTING LIGHT POLE
---	EXISTING FIRE HYDRANT	---	EXISTING UTILITY POLE
---	EXISTING GAS LINE	---	EXISTING AIR CONDITIONER
---	EXISTING GAS METER	---	EXISTING TELEPHONE PEDESTAL
---	EXISTING SANITARY SEWER	---	EXISTING ELECTRICAL TRANSFORMER
---	STORM/SANITARY MANHOLE	---	EXISTING ELECTRIC METER
---	EXISTING SANITARY SEWER LATERAL	---	EXISTING CONCRETE
---	EXISTING UNDERGROUND ELECTRIC	---	EXISTING ASPHALT
---	EXISTING UNDERGROUND FIBER OPTIC	---	PROPOSED CONCRETE
---	EXISTING STEAM CHASE	---	EXISTING SIGN
---	EXISTING STORM SEWER	---	EXISTING POST AND CHAIN FENCE
---	BEEHIVE INLET	---	EXISTING BRICK PAVERS
---	PROPOSED CURB		
---	EXISTING STRUCTURE		



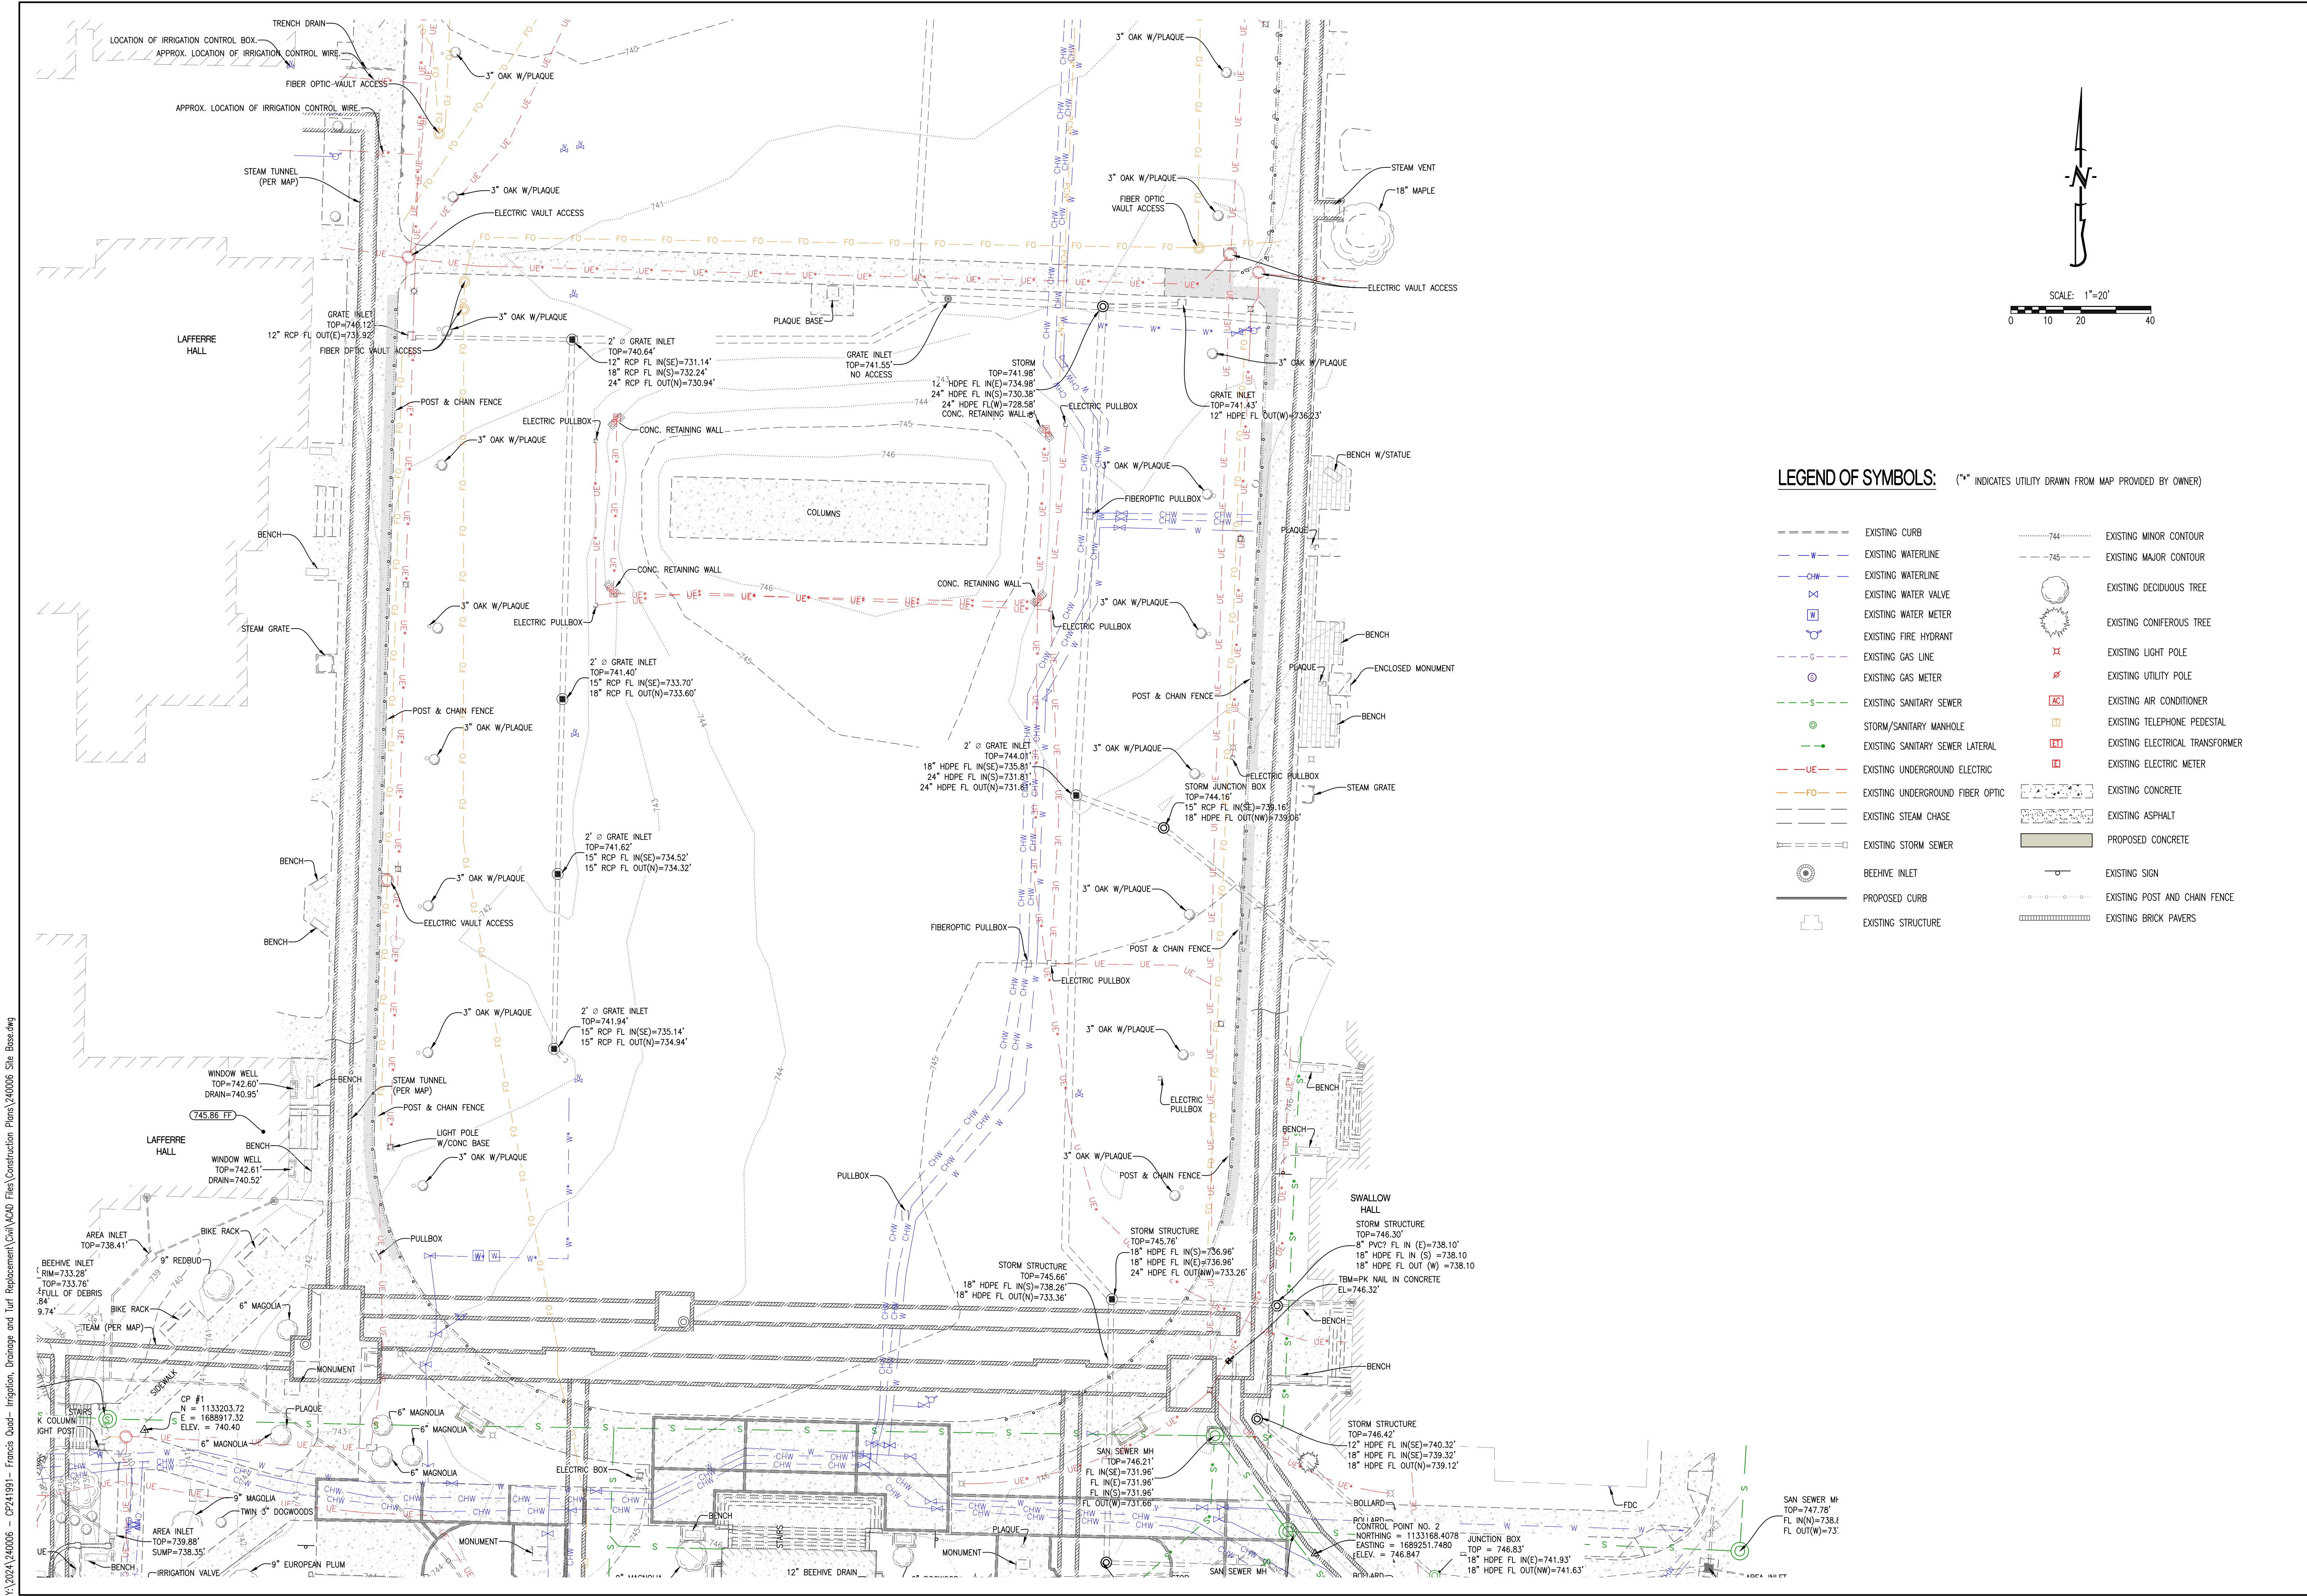

**REVISIONS:**

NO.	DATE
BID SET	03/20/2024

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NATHAN THOMAS ECKHOFF  
MO LICENSE 200304960


PREPARED BY: **CROCKETT ENGINEERS & ARCHITECTS**  
1000 W. Illinois Blvd., Ste. 100  
Columbia, Missouri 65203  
(314) 487-0299  
www.crockettengineering.com  
Missouri Certificate of Authority #00000001

OWNER: THE COLLEGE OF THE UNIVERSITY OF MISSOURI  
POST OFFICE BOX 1000  
COLUMBIA, MISSOURI 65211

**CP241991 - FRANCIS QUADRANGLE  
IRRIGATION, DRAINAGE, AND TURF REPLACEMENT**  
COLUMBIA, BOONE COUNTY, MISSOURI

DRAWING INCLUDES:  
EXISTING CONDITIONS SOUTH QUAD

DESIGNED: NTE  
DRAWN: NMD  
PROJECT NO.: CP241991  
SHEET: CE 12

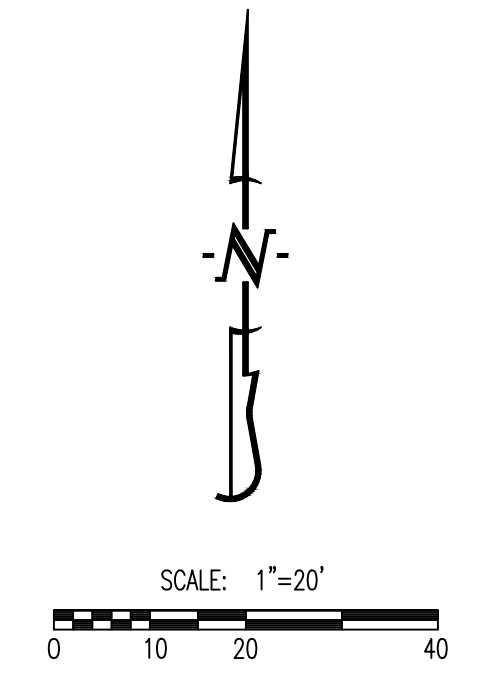



**LEGEND OF SYMBOLS:** (\* INDICATES UTILITY DRAWN FROM MAP PROVIDED BY OWNER)

- |     |                                  |               |                                 |
|-----|----------------------------------|---------------|---------------------------------|
| --- | EXISTING CURB                    | .....744..... | EXISTING MINOR CONTOUR          |
| --- | EXISTING WATERLINE               | ---745---     | EXISTING MAJOR CONTOUR          |
| --- | EXISTING WATERLINE               | ○             | EXISTING DECIDUOUS TREE         |
| --- | EXISTING WATER VALVE             | ○             | EXISTING CONIFEROUS TREE        |
| --- | EXISTING FIRE HYDRANT            | ○             | EXISTING LIGHT POLE             |
| --- | EXISTING GAS LINE                | ○             | EXISTING UTILITY POLE           |
| --- | EXISTING GAS METER               | ○             | EXISTING AIR CONDITIONER        |
| --- | EXISTING SANITARY SEWER          | ○             | EXISTING TELEPHONE PEDESTAL     |
| --- | STORM/SANITARY MANHOLE           | ○             | EXISTING ELECTRICAL TRANSFORMER |
| --- | EXISTING SANITARY SEWER LATERAL  | ○             | EXISTING ELECTRIC METER         |
| --- | EXISTING UNDERGROUND ELECTRIC    | ○             | EXISTING CONCRETE               |
| --- | EXISTING UNDERGROUND FIBER OPTIC | ○             | EXISTING ASPHALT                |
| --- | EXISTING STEAM CHASE             | ○             | PROPOSED CONCRETE               |
| --- | EXISTING STORM SEWER             | ○             | EXISTING SIGN                   |
| ○   | BEEHIVE INLET                    | ○             | EXISTING POST AND CHAIN FENCE   |
| --- | PROPOSED CURB                    | ○             | EXISTING BRICK PAVERS           |
| --- | EXISTING STRUCTURE               |               |                                 |

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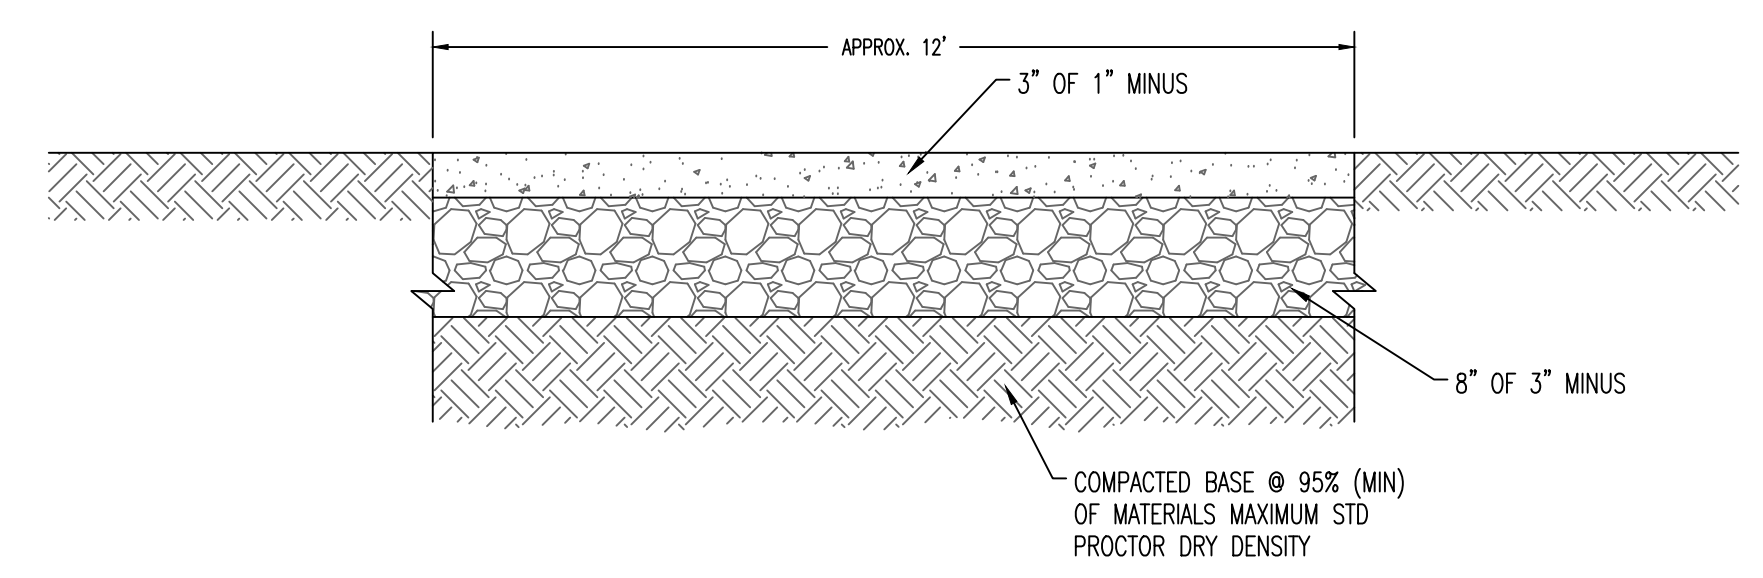


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- LEGEND OF LABELS**
- (A) CONTRACTOR TO INSTALL TEMPORARY 6' HIGH CHAIN LINK FENCE W/ GATES AND SCREENING ATTACHED AS SHOWN. REFER TO SCREENING PATTERN ON THIS SHEET FOR REFERENCE. THIS IS TO REMAIN FOR THE ENTIRETY OF THE PROJECT.
  - (B) CONTRACTOR TO USE EXISTING PAVING AS CONSTRUCTION ENTRY AND EXIT AND STAGING AREA WITHIN THE FENCE LIMITS. ALL CONSTRUCTION TRAFFIC SHALL UTILIZE THIS ENTRY AND EXIT TO THE PROJECT. ANY DAMAGED PAVEMENT DURING CONSTRUCTION SHALL BE REPLACED BY THE CONTRACTOR. CONTRACTOR SHALL CLEAN/POWER WASH CONSTRUCTION AREA PAVEMENT ONCE WORK IS COMPLETE.
  - (C) EXISTING BOLLARDS TO BE REMOVED FOR CONSTRUCTION ENTRANCE AS SHOWN ON FRANCIS QUADRANGLE STEAM TUNNEL REPLACEMENT PLANS. CONTRACTOR SHALL COORDINATE SHARING 8TH STREET CONSTRUCTION ENTRANCE WITH FRANCIS QUADRANGLE STEAM TUNNEL AND GEOLOGY STEAM PROJECTS WITH OWNER'S REPRESENTATIVE.
  - (D) APPROXIMATE LOCATION OF TEMPORARY CONSTRUCTION FENCING FOR ADJACENT PROJECT. CONTRACTOR SHALL COORDINATE SITE LOGISTICS AMONGST ADJACENT CONCURRENT PROJECTS WITH OWNER'S REPRESENTATIVE.
  - (E) LIMITS OF DISTURBANCE.
  - (F) INSTALL SILT FENCE AROUND EXISTING INLET DURING ROUGH GRADING.
  - (G) EXISTING SIDEWALK TO BE RECONSTRUCTED AS SHOWN ON FRANCIS QUADRANGLE STEAM TUNNEL REPLACEMENT PLANS. CONTRACTOR TO COORDINATE WORK IN THIS AREA WITH OWNER'S REPRESENTATIVE.
  - (H) INSTALL GRAVEL DRIVE AS SHOWN TO PREVENT RUTTING AND COMPACTION OF EXISTING SOIL.
  - (I) CONTRACTOR TO INSTALL PROTECTION FENCING AROUND TREES AND COLUMNS AS SHOWN. REFER TO DETAIL ON L-201.
  - (J) EXISTING SIDEWALK TO REMAIN OPEN FOR PEDESTRIANS THROUGHOUT DURATION OF PROJECT. ANY DAMAGED PAVEMENT DURING CONSTRUCTION SHALL BE REPLACED BY THE CONTRACTOR. CONTRACTOR SHALL CLEAN/POWER WASH CONSTRUCTION AREA PAVEMENT ONCE WORK IS COMPLETE.
  - (K) EXISTING CONTROL BOX LOCATED NEAR SOUTHEAST CORNER OF SWITZLER HALL. CONTRACTOR TO REUSE EXISTING WIRE AS PULL WIRE. COORDINATE WITH OWNER'S REPRESENTATIVE.
  - (L) GRAVEL DRIVE, INSTALLED BY OTHERS. CONTRACTOR TO COORDINATE SITE LOGISTICS WITH OWNER'S REPRESENTATIVE.


- LEGEND:**
- FENCE TO BE INSTALLED BY CONTRACTOR OF THIS PROJECT.
  - FENCE TO BE INSTALLED BY OTHERS FOR ADJACENT PROJECTS. CONTRACTOR TO COORDINATE WITH OWNER'S REPRESENTATIVE.
  - FENCE TO BE INSTALLED BY OWNER FOR THIS PROJECT ONLY.
  - PROTECTIVE FENCING TO BE INSTALLED FOR TREES AND COLUMNS BY CONTRACTOR OF THIS PROJECT.
  - PEDESTRIAN ACCESS ROUTE TO REMAIN OPEN AT ALL TIMES.

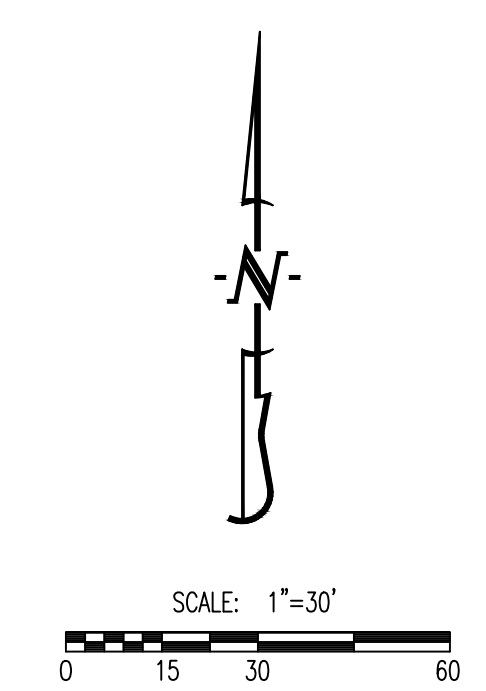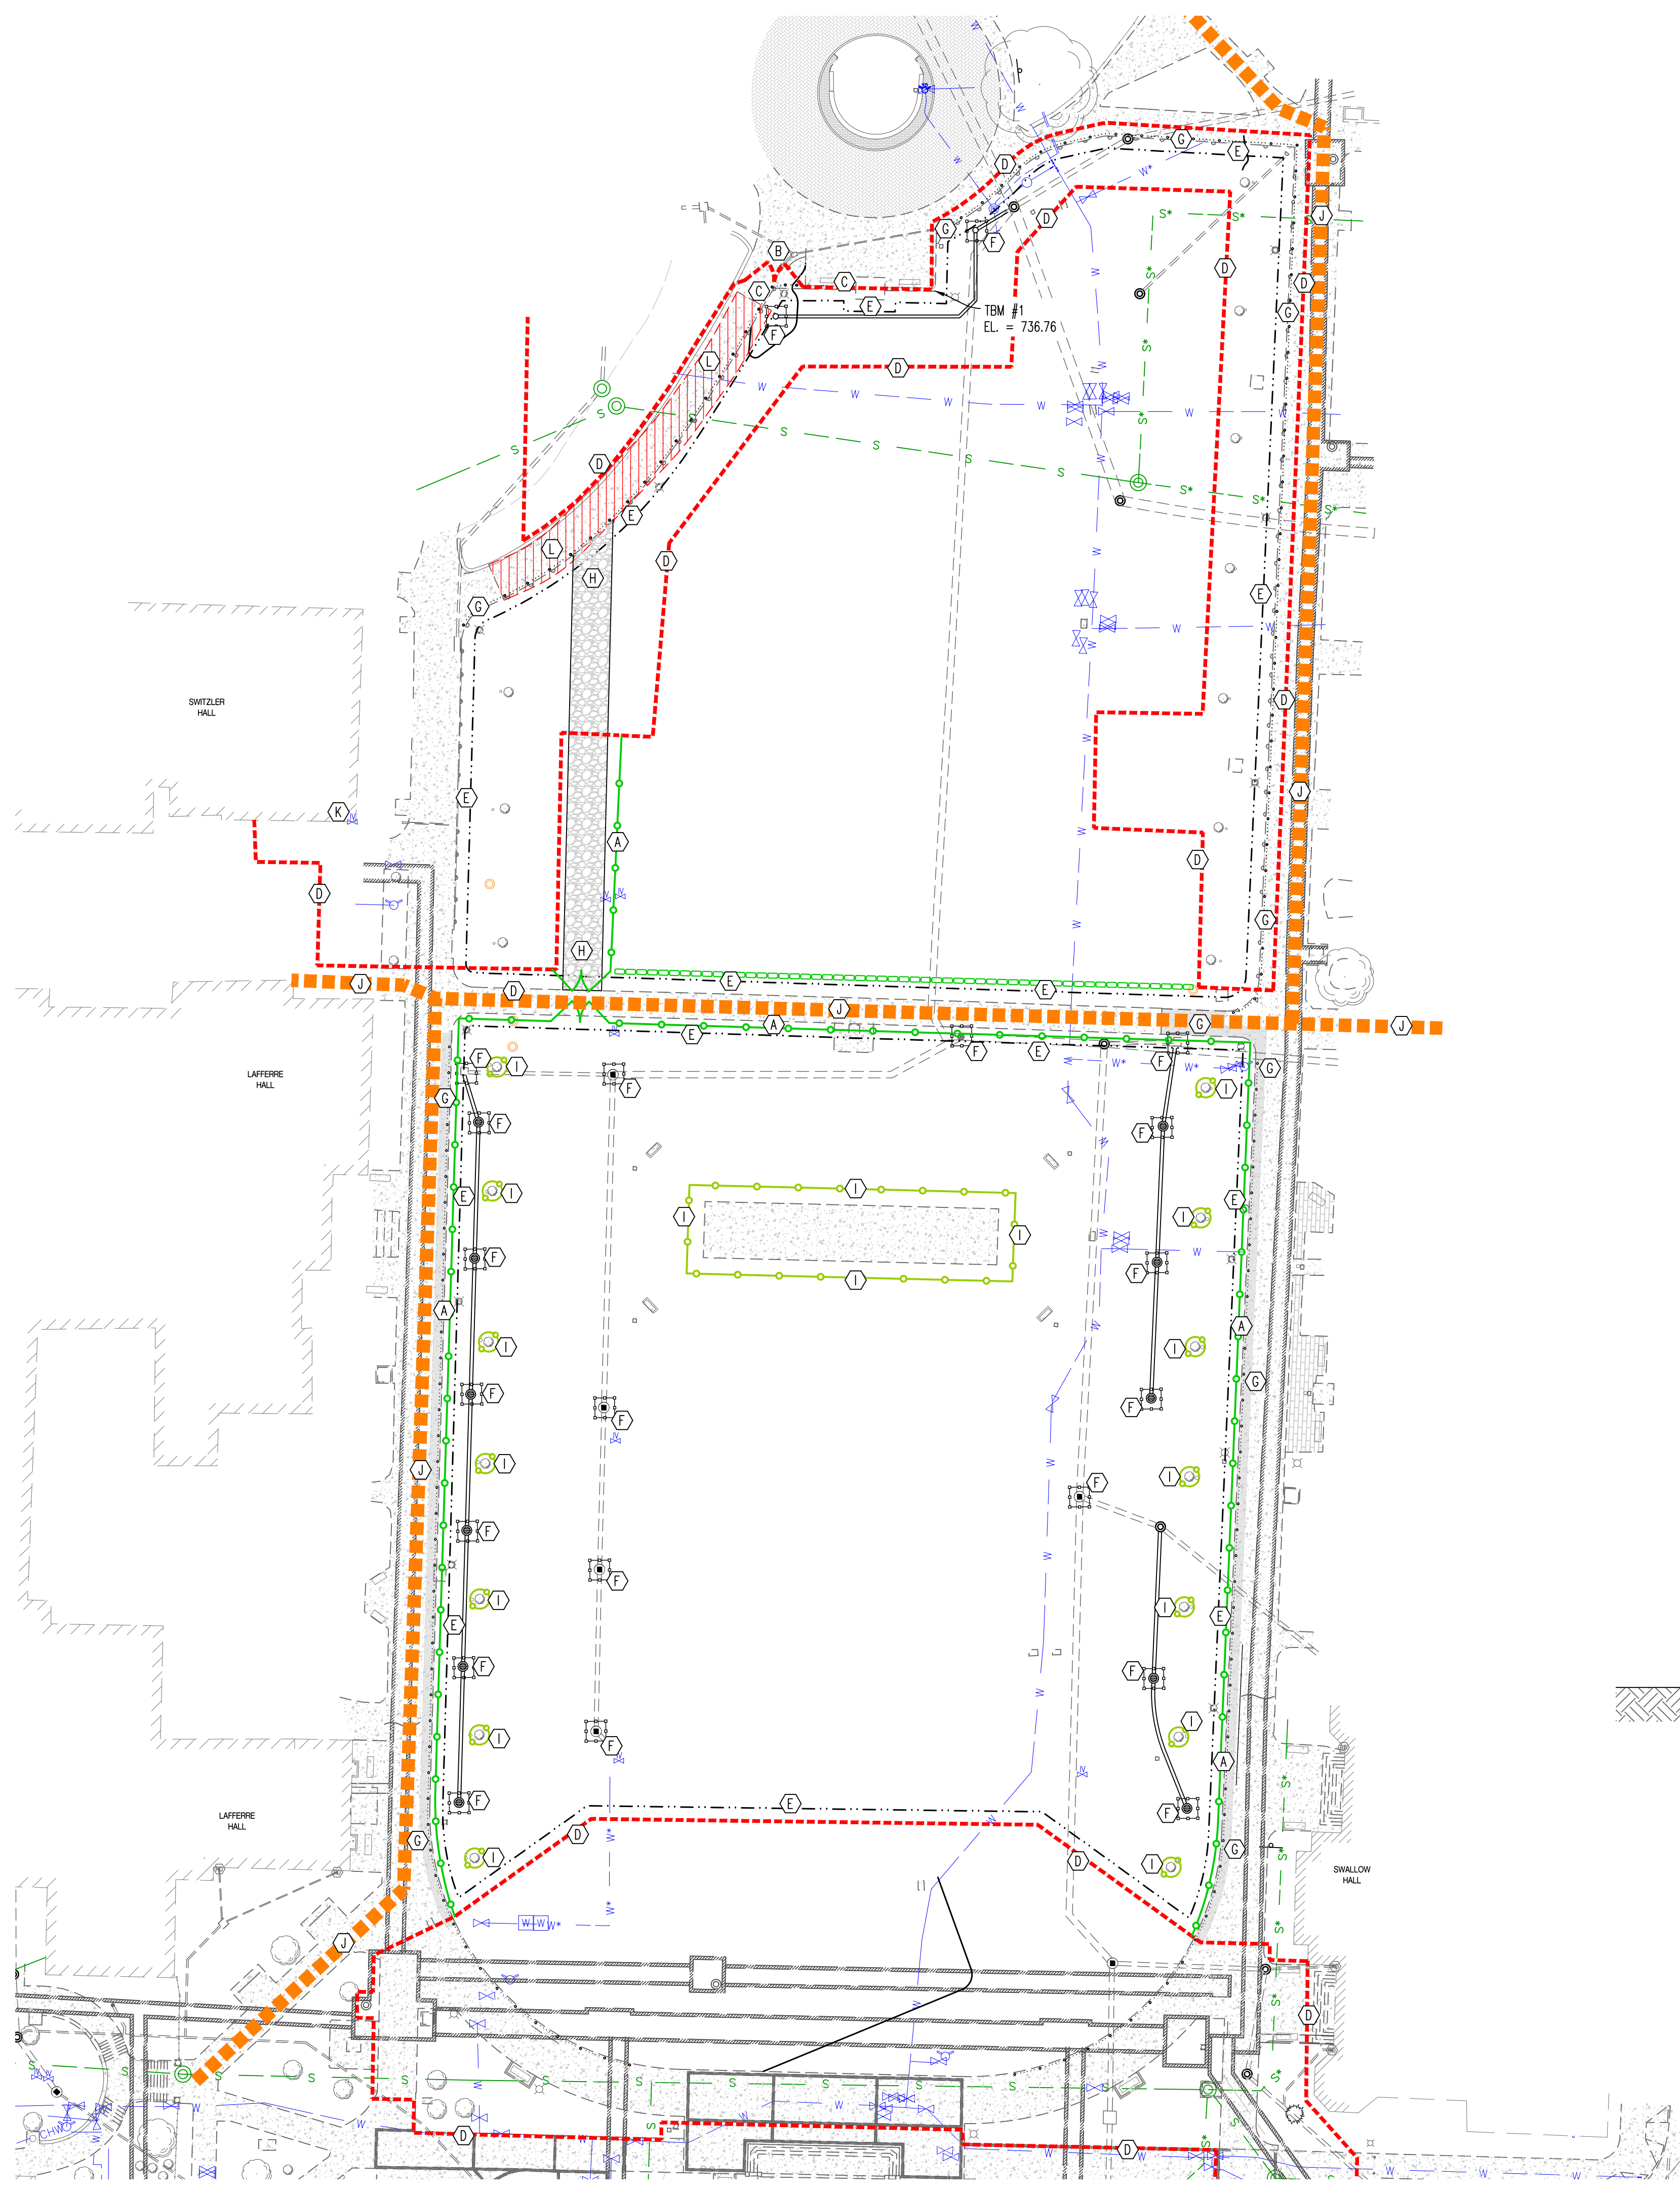

TYPICAL TEMPORARY ACCESS DRIVE AND LAY DOWN AREA CROSS-SECTION




TIGER STRIPE FENCE SCREENING PATTERN
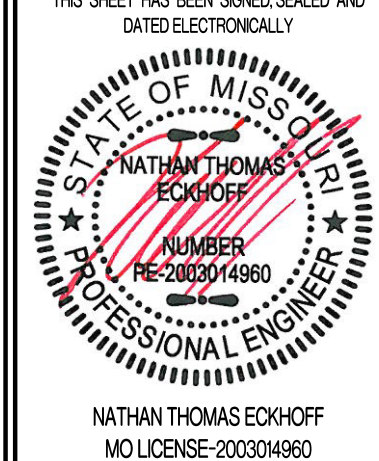
<b>REVISIONS:</b>	
NO.	DATE
BID SET	03/20/2024
<small>THIS SHEET HAS BEEN SIGNED, SEALED AND DATED ELECTRONICALLY</small> 	
<small>PREPARED BY:</small> <b>CROCKETT ENGINEERS &amp; ARCHITECTS</b> <small>1000 W. Illinois Blvd., Suite 200          Columbia, Missouri 65203          (314) 487-0200          www.crockettengineering.com          Missouri Certificate of Authority #00000001</small>	
<small>OWNER:</small> THE COURTESY OF THE UNIVERSITY OF MISSOURI 500 S. MURPHY HALL CIVIL BUSINESS SERVICES COLUMBIA, MO 65211	
<b>CP241991 - FRANCIS QUADRANGLE IRRIGATION, DRAINAGE, AND TURF REPLACEMENT</b> COLUMBIA, BOONE COUNTY, MISSOURI	
<b>DRAWING INCLUDES:</b>	
EROSION CONTROL AND SITE ACCESS PLAN	
<b>DESIGNED:</b>	NTE
<b>DRAWN:</b>	NMD
<b>PROJECT NO.:</b>	CP241991
<b>SHEET:</b>	CE 21



Drawing name: K:\KNC\_LAV268642000\_MU FRANCIS QUAD2.DESIGN\CAD\PLANS\HEETS\L-100 GRADING.DWG Plot date: Friday, March 15, 2024 4:12:02 PM by: Lake, Debra Last saved: 3/15/2024 4:02 PM  
 This document, together with the concepts and designs presented herein, is intended only for the specific purpose and client for which it was prepared. Reuse of and improper reliance on this document without written authorization and adaptation by Kimley-Horn and Associates, Inc. shall be without liability to Kimley-Horn and Associates, Inc.

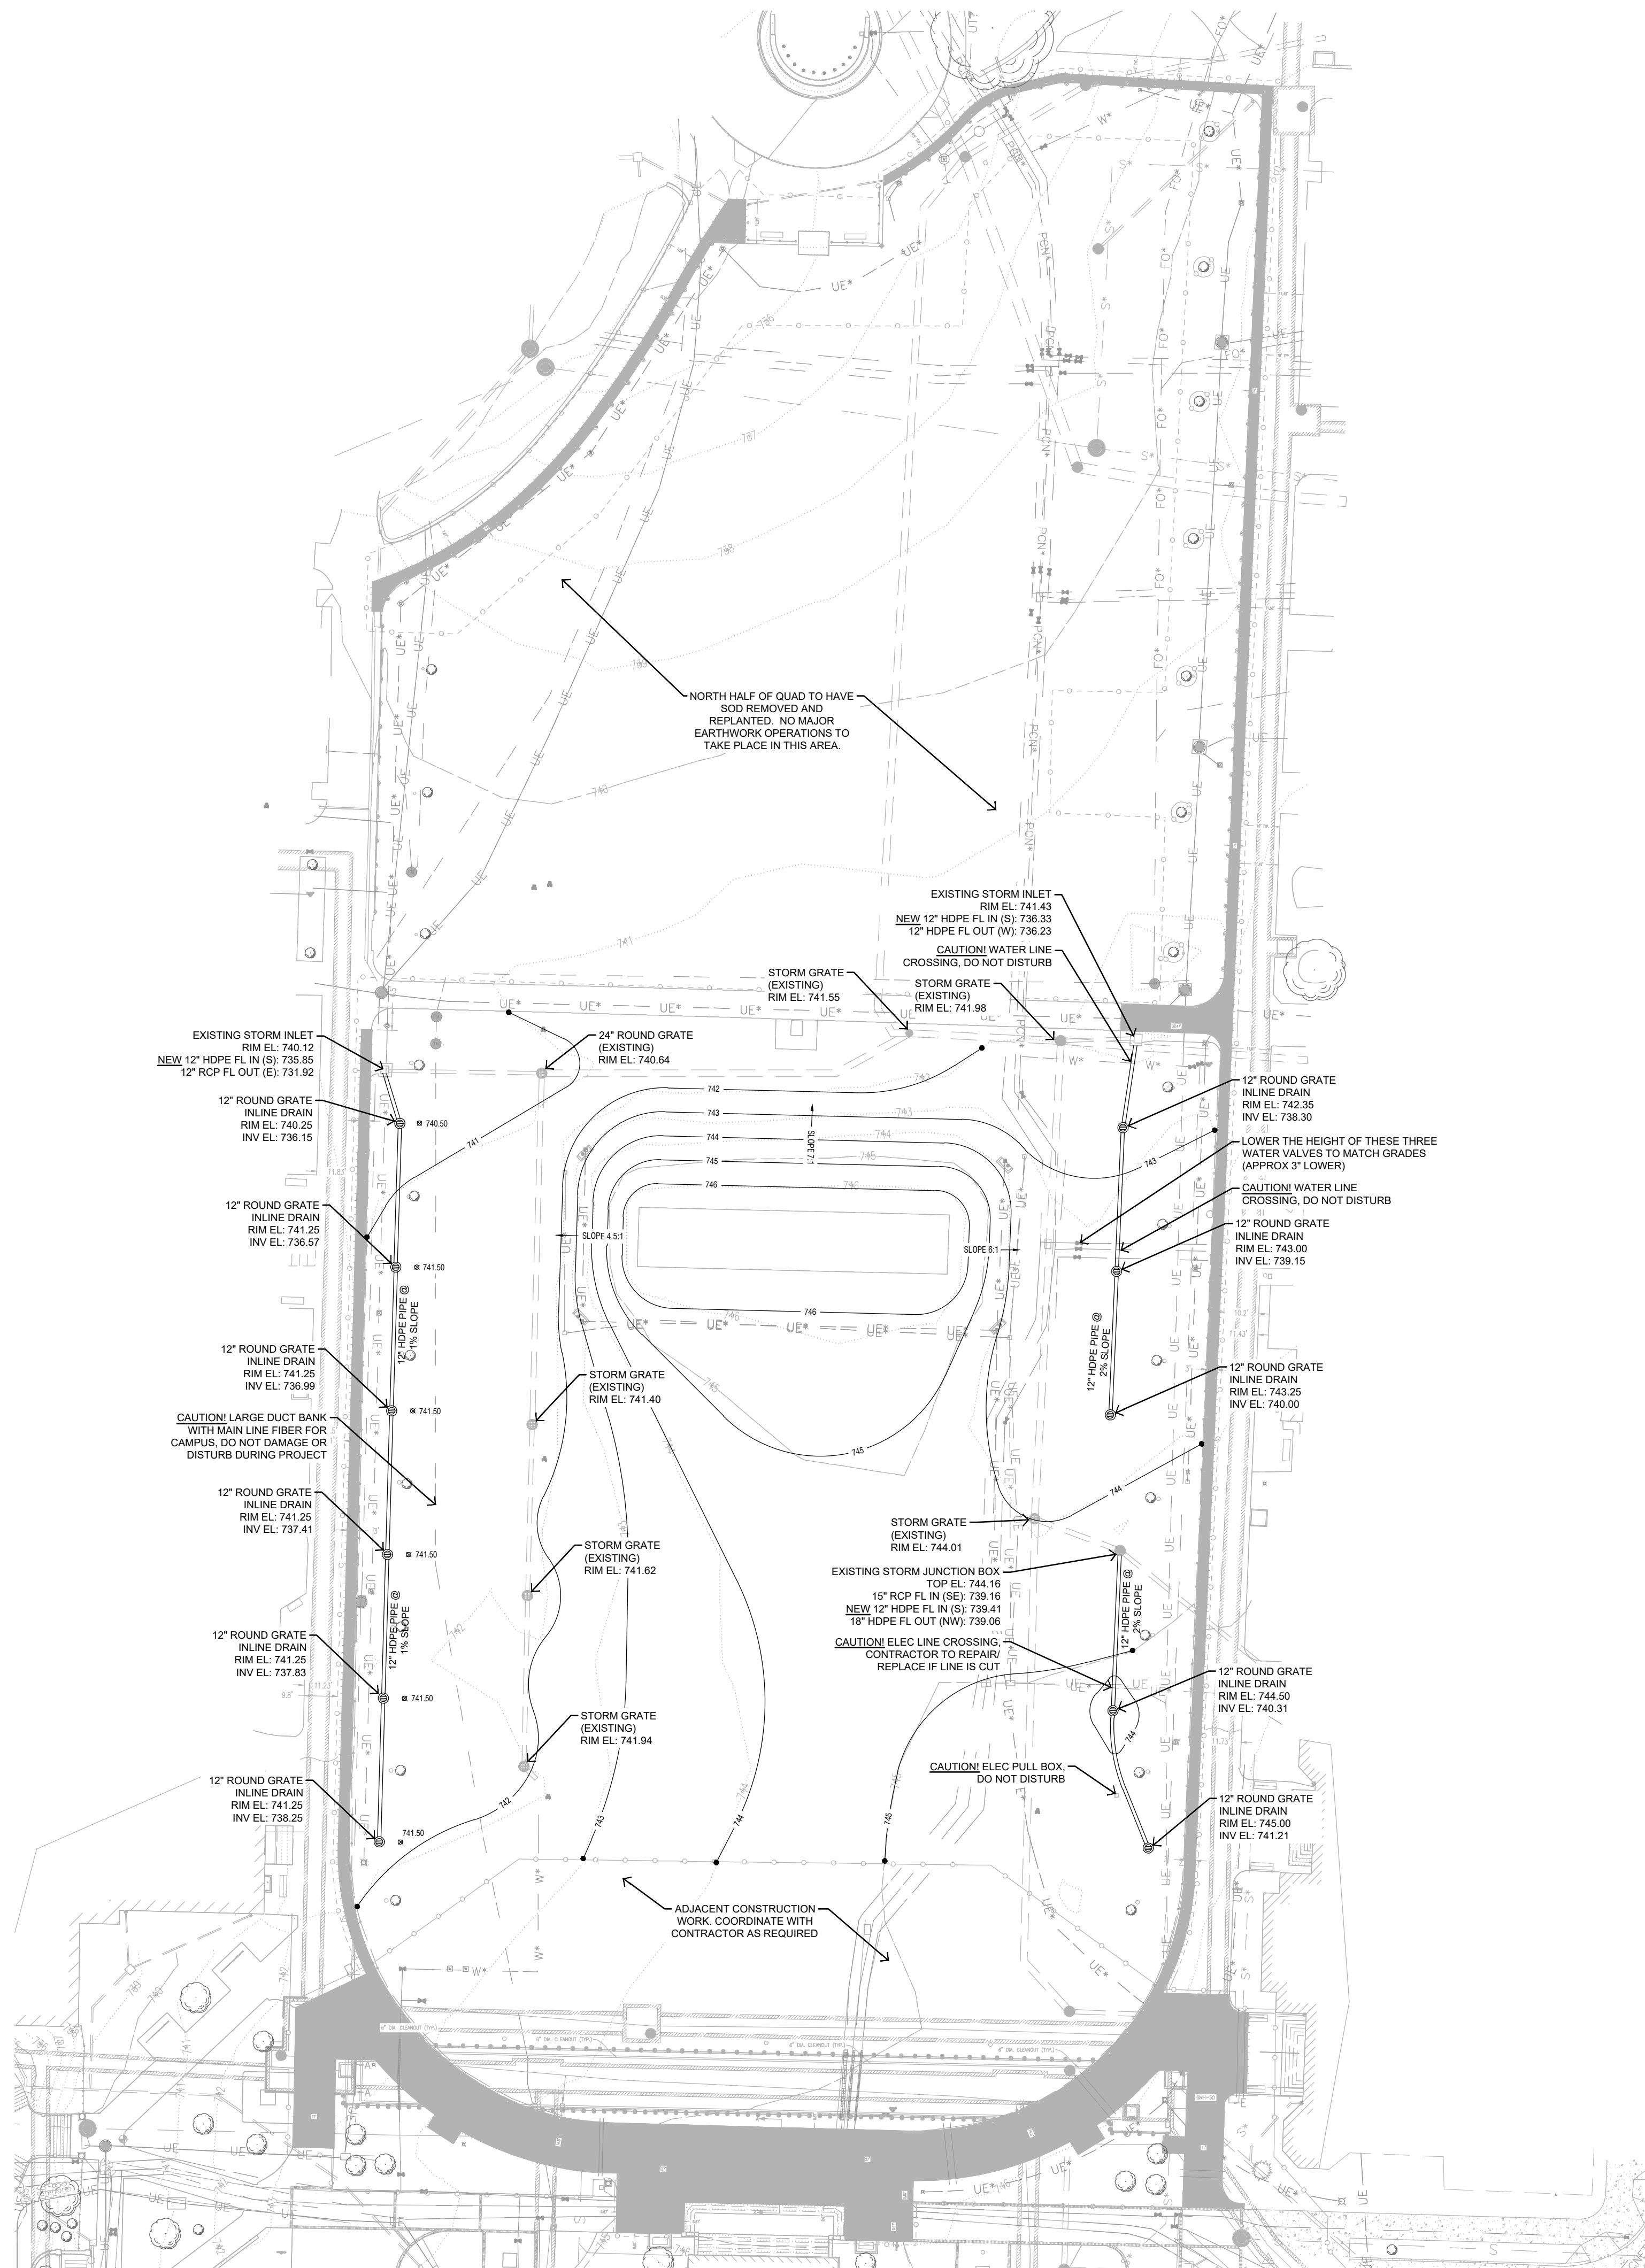

**GRADING LEGEND:**




- ⊕xxx.xx PROPOSED SPOT ELEVATION
- xxx- PROPOSED CONTOUR
- ⊕ PROPOSED 12" HDPE STORM PIPE WITH ADS INLINE DRAIN AND GRATE

**GRADING NOTES:**


1. STRIP 6" EXISTING TOPSOIL IN AREAS OF MAJOR EARTHWORK OPERATIONS IN THE SOUTH HALF OF THE QUAD AS OUTLINED IN SOD SPECIFICATIONS.
2. REMOVE EXISTING TURF MATERIAL IN NORTH HALF OF QUAD FOR INSTALLATION OF NEW SOD.
3. ALL EARTHWORK OPERATIONS TO COMPLY WITH SOIL AMENDMENTS AND SOD PREP REQUIREMENTS AS OUTLINED IN SOD SPECIFICATIONS.
4. THE GENERAL CONTRACTOR SHALL VERIFY ALL EXISTING SITE CONDITIONS SHOWN ON PLAN. ANY DISCREPANCIES NOTED IN THE FIELD SHALL BE RELAYED TO THE OWNER PRIOR TO COMMENCEMENT OF WORK.
5. UNDERGROUND IMPROVEMENTS MAY VARY FROM SURVEY AND CONTRACTOR SHALL USE CAUTION DURING ANY EARTHWORK OPERATIONS NEAR EXISTING UTILITIES. ANY UTILITIES DAMAGED BY CONTRACTOR SHALL BE REPAIRED AT CONTRACTOR'S EXPENSE.
6. ROOT SYSTEMS FROM REMOVED TREES MAY STILL EXIST WITHIN TOP 6" OF SOIL TO BE REMOVED. THESE ROOTS SHALL BE REMOVED. USE CAUTION AS TO NOT DAMAGE UTILITIES DURING THE REMOVAL PROCESS.
7. CONTRACTOR TO REPAIR ANY DAMAGE TO WIRING ASSOCIATED WITH SITE LIGHTING OR SECURITY CAMERAS WITHIN 12 HOURS.
8. PROVIDE POSITIVE DRAINAGE AT ALL TIMES WITHIN THE CONSTRUCTION AREA. CONTRACTOR SHALL GRADE ALL LOW SPOTS TO DRAIN.
9. ALL NEW STORM PIPES TO BE 12" ADS HDPE WITH INLINE DRAIN BASINS AND 12" GRATES (OR APPROVED EQUAL)
10. DEMO AND REMOVE EXISTING IRRIGATION SYSTEM TO BE REPLACED IN SOUTH HALF OF QUAD. IF ADD ALTERNATE FOR NEW IRRIGATION SYSTEM IN NORTH HALF OF QUAD IS TAKEN, EXISTING IRRIGATION IN THAT AREA SHALL BE REMOVED AS WELL.

**NOTES:**

1. REFER TO PLAN FOR INVERT ELEVATION INFORMATION.
2. CONNECT TO INLINE DRAINS PER MANUFACTURER RECOMMENDATIONS AS SHOWN ON PLANS.
3. SLOPE ALL PIPES TO HAVE POSITIVE DRAINAGE WITH MIN. 1% SLOPE.
4. CONNECT INTO EXISTING INLETS AS SHOWN ON PLANS. SEAL NEW CONNECTION POINTS AS REQUIRED.

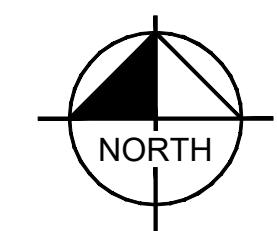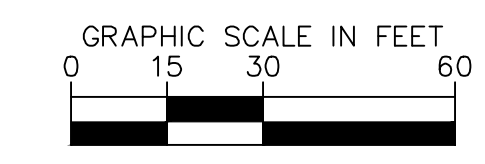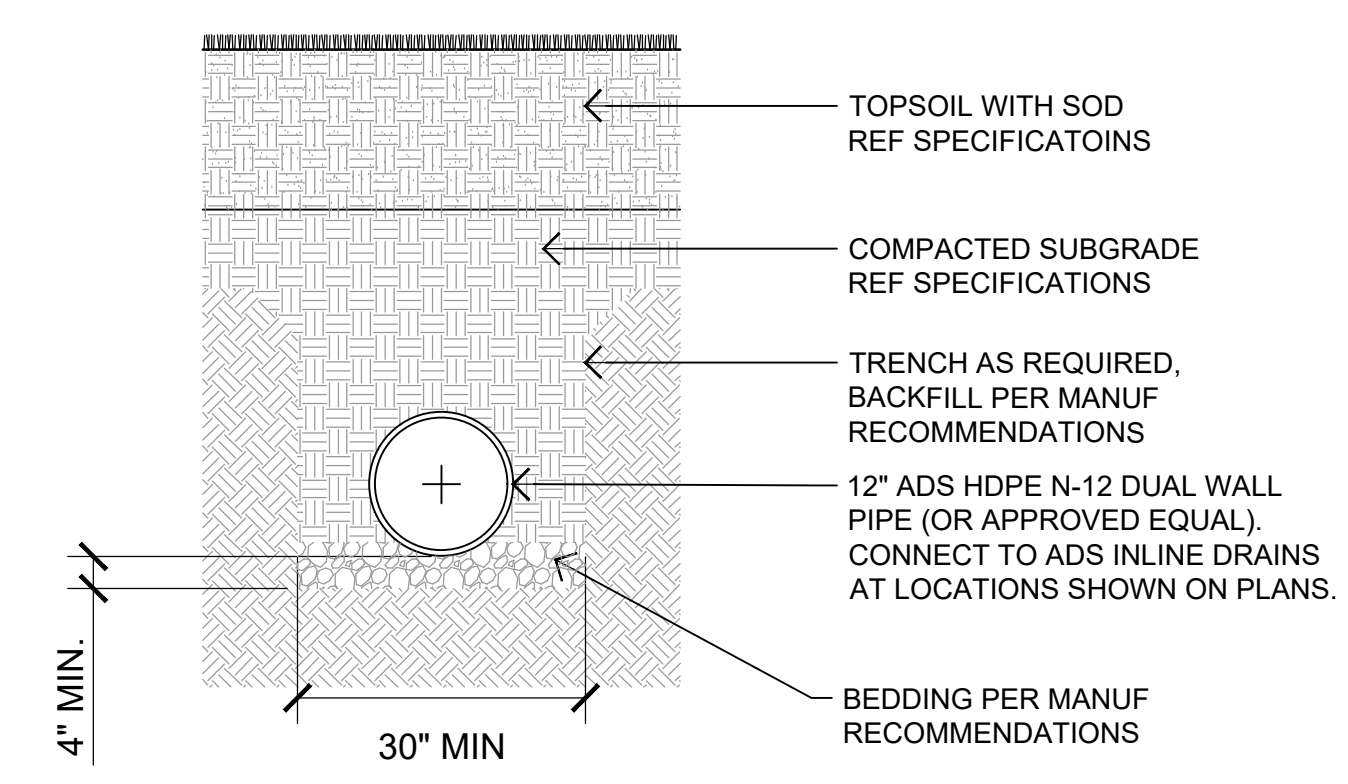

**Kimley-Horn**  
 805 PENNSYLVANIA AVENUE, SUITE 150  
 KANSAS CITY, MO 64105  
 PHONE: 816-234-5000  
 WWW.KH.COM  
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KHA PROJECT	268642000
DATE	03/20/2024
SCALE	AS SHOWN
DESIGNED BY	JDK
DRAWN BY	DLL
CHECKED BY	SAR

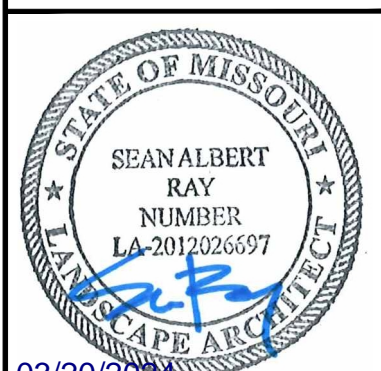**GRADING AND STORM SEWER PLAN**


**CP241991 FRANCIS QUADRANGLE IRRIGATION, DRAINAGE, AND TURF REPLACEMENT**

SHEET NUMBER  
**L-100**

No.	REVISIONS	DATE	BY



Drawing name: K:\KNC\_LA\268642000\_MU FRANCIS QUAD2.DESIGN\CAD\PLANS\HETS\200 PLANTING.DWG Plot date: Friday, March 15, 2024 4:12:13 PM by: Lake, Debra Last saved: 3/15/2024 4:06 PM  
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**PLANT SCHEDULE**


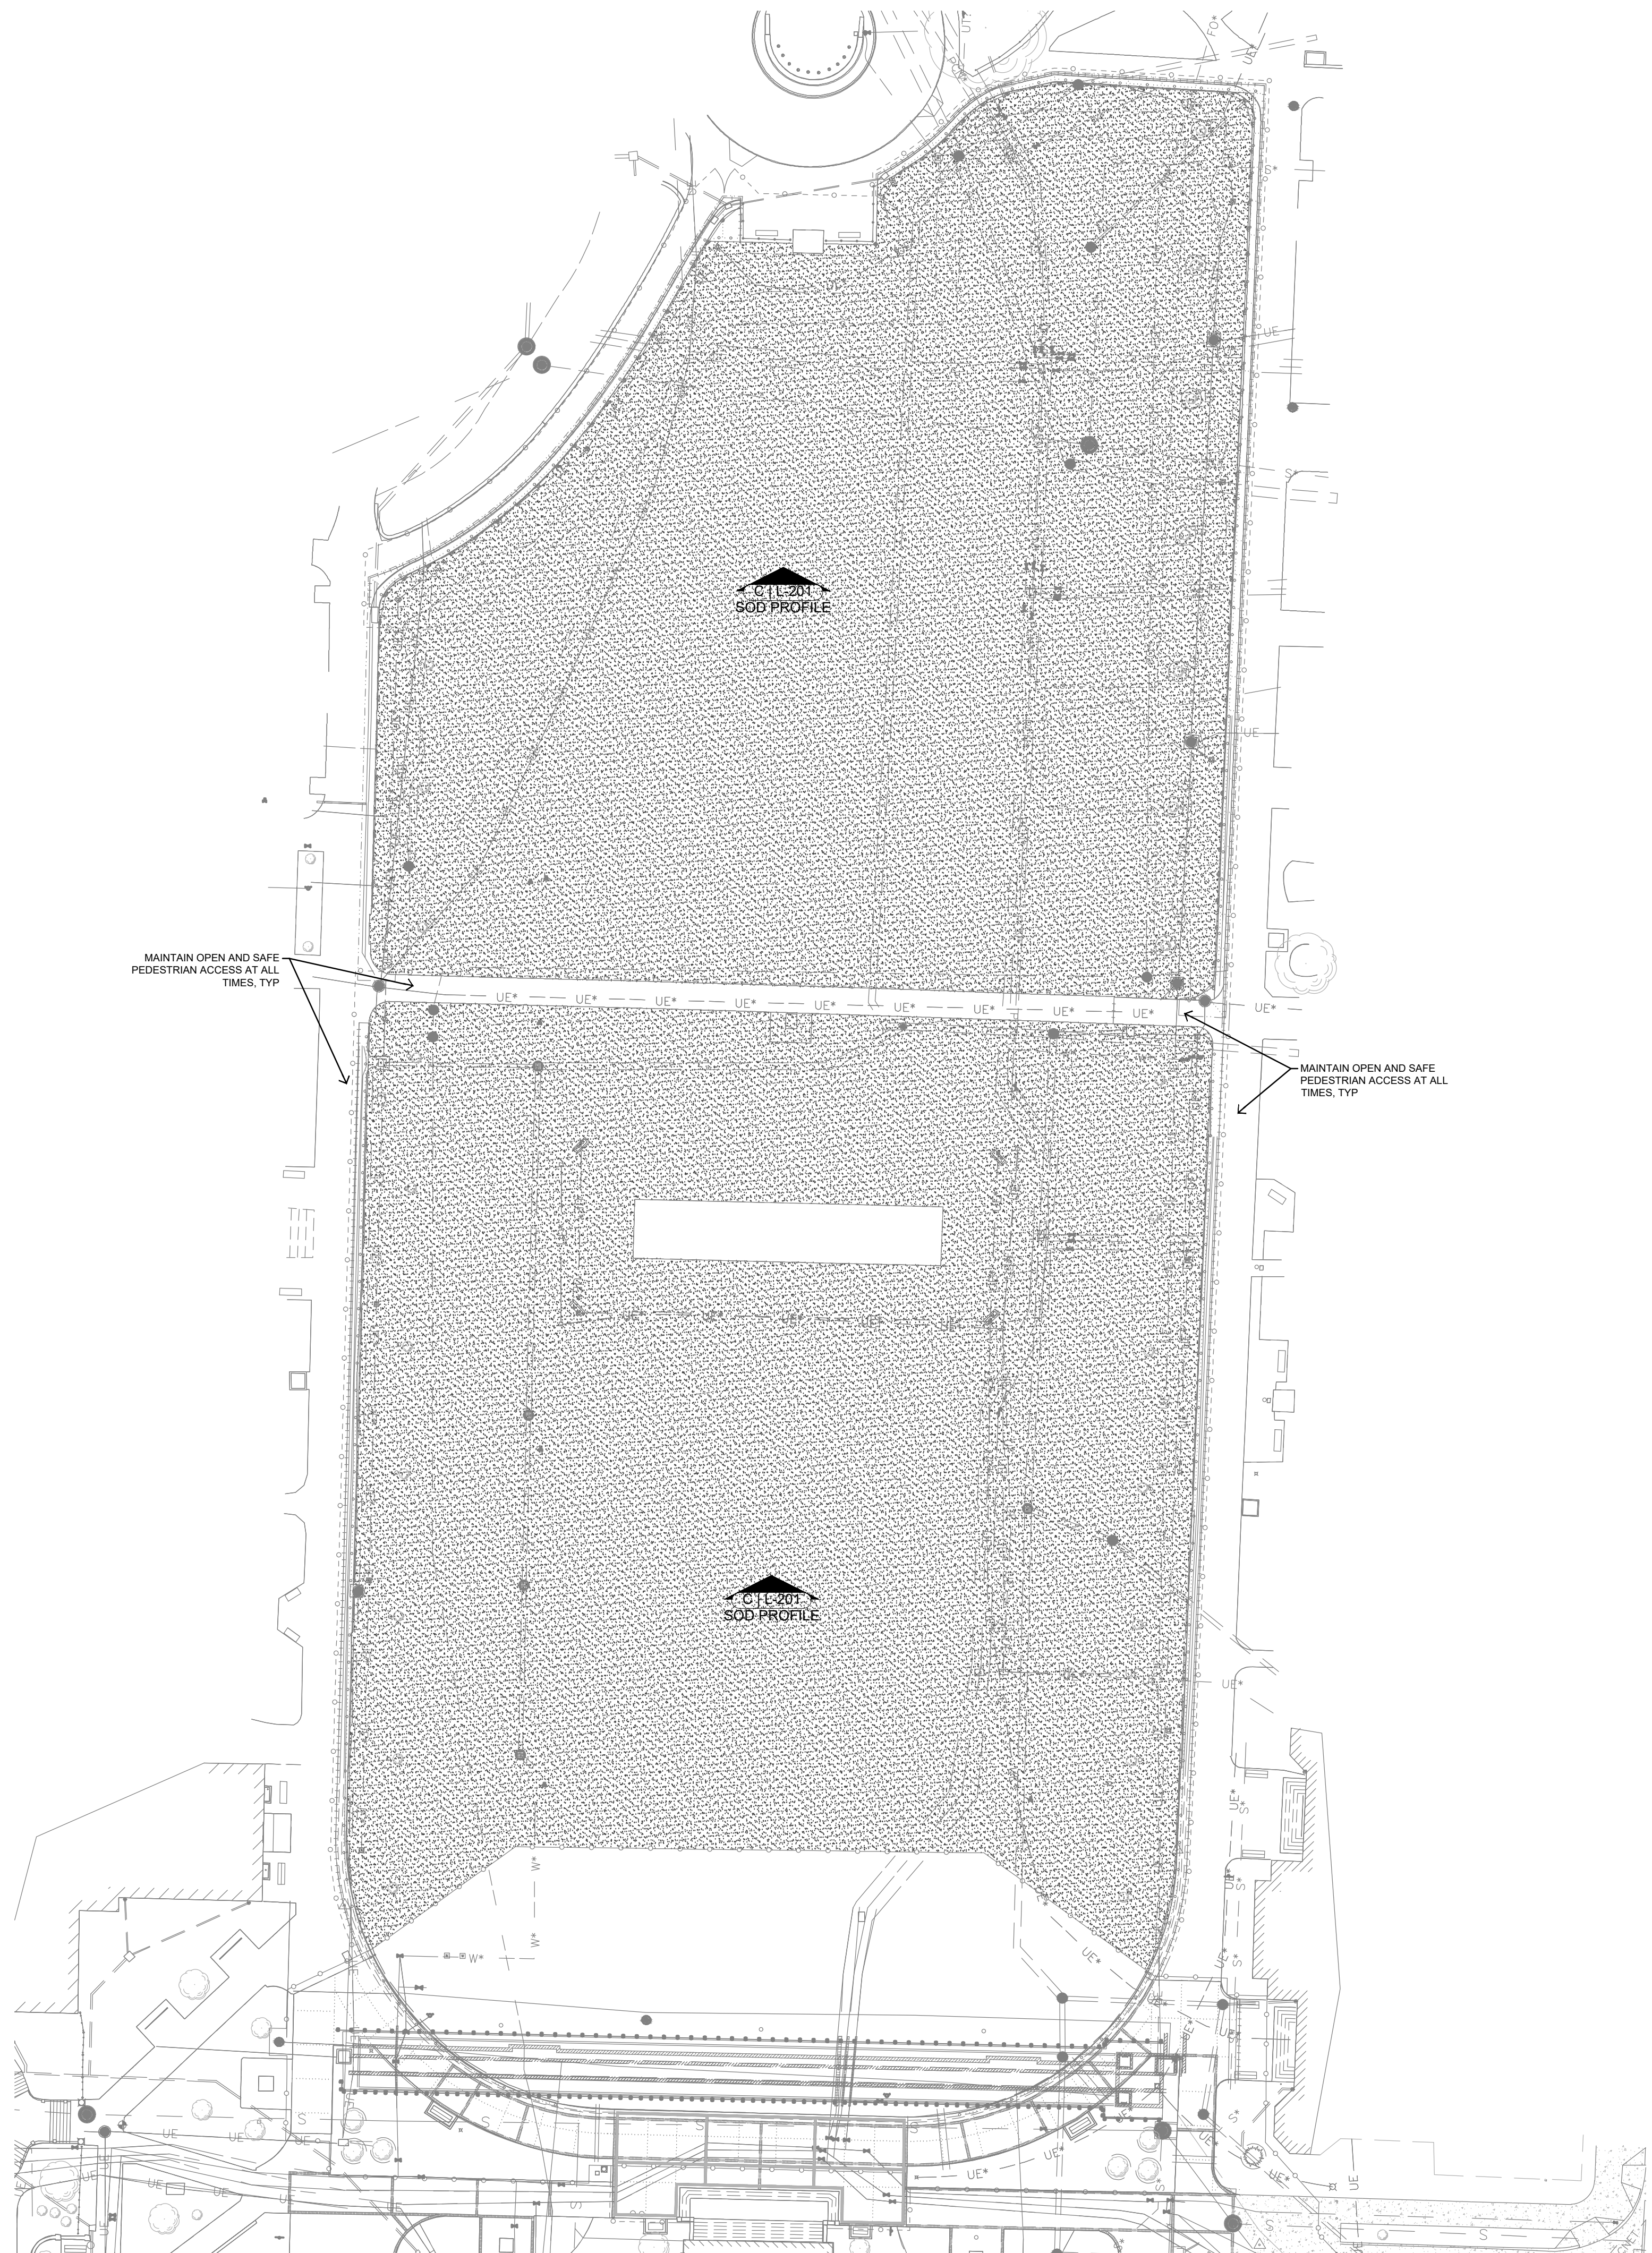
SYMBOL	CODE	QTY	BOTANICAL / COMMON NAME	REMARKS
	FI	114,233 SF	FESTUCA ARUNDINACEA 'BLACK BEAUTY' / BLACK BEAUTY TALL FESCUE	SOD TO HAVE TIGHT, SAND-FILLED JOINTS, ROLLED. SOD TO BE FREE OF WEEDS, PESTS, AND DISEASE.

**TREE PRESERVATION NOTES:**

- CONTRACTOR SHALL ADHERE TO ALL TREE PRESERVATION REQUIREMENTS LISTED HEREIN.
- CONTRACTOR SHALL COORDINATE ALL CONSTRUCTION PROCEDURES WITH THE OWNER PRIOR TO BEGINNING WORK.
- ANY DEMOLITION OR EXCAVATION WITHIN THE DRIP LINE OF AN EXISTING TREE SHALL PROCEED WITH EXTREME CARE EITHER BY THE USE OF HAND TOOLS, DIRECTIONAL BORING, AIR KNIFE EXCAVATION, AND/OR WITH OTHER LOW IMPACT EQUIPMENT THAT WILL NOT CAUSE DAMAGE TO THE TREE, ROOTS, OR SOIL; CONTRACTOR SHALL COORDINATE SUCH PROCEDURES WITH THE PROJECT ARBORIST.
- EXISTING TREE LOCATIONS AND SIZES ARE ESTIMATES BASED ON A SURVEY PROVIDED BY THE OWNER SELECTED SURVEYOR.
- NO SIGNS, BUILDING PERMITS, WIRES, OR OTHER ATTACHMENTS OF ANY KIND SHALL BE ATTACHED TO ANY TREE. GUY WIRES DESIGNED TO PROTECT TREES ARE EXCLUDED FROM THIS PROHIBITION.
- DO NOT INSTALL CONDUIT, DRAIN OR IRRIGATION LINE, OR ANY UTILITY LINE WITHIN THE TREE PROTECTION ZONE WITHOUT THE APPROVAL OF THE OWNER. IF LINES MUST TRAVERSE THE PROTECTION AREA, THEY SHALL BE TUNNELED OR BORED UNDER THE TREE UNLESS OTHERWISE NOTED—REFERENCE TREE PRESERVATION DETAILS.
- CONSTRUCTION ACTIVITY SHALL NOT DESTROY OR IRREVERSIBLY HARM THE ROOT SYSTEM OF PROTECTED TREES. POST HOLES AND TRENCHES LOCATED CLOSE TO PROTECTED TREES SHALL BE ADJUSTED TO AVOID DAMAGE TO MAJOR ROOTS.
- IF TREE ROOT ZONE IS TO BE DISTURBED, AFFECTED ROOTS MUST BE SEVERED BY CLEAN PRUNING CUTS AT THE POINT WHERE CONSTRUCTION IMPACTS THE ROOTS.
- ROOT PRUNING/TRENCHING LOCATIONS SHALL BE PERFORMED BY OWNER'S REPRESENTATIVE.
- IF ANY DAMAGE TO TREE PROTECTION FENCING SHOULD OCCUR BY ACCIDENT OR NEGLIGENCE, THE CONTRACTOR SHALL BE RESPONSIBLE FOR IMMEDIATE REPAIRS.
- CONTRACTOR'S ACCESS TO FENCED TREE PROTECTION AREAS SHALL BE PERMITTED ONLY WITH APPROVAL OF THE OWNER.
- NO MATERIALS, EQUIPMENT, SPOIL, WASTE, OR WASHOUT WATER MAY BE DISPOSED, STORED, OR PARKED WITHIN 20 FEET OF ANY TREE PROTECTION ZONE.
- CONTRACTOR SHALL COORDINATE WITH THE OWNER PRIOR TO REMOVAL OF TREE PROTECTION FENCING.

**PLANTING NOTES:**

- CONTRACTOR TO SOD TO LIMITS OF DISTURBANCE. REFER TO SPECIFICATIONS.
- ALL PLANT MATERIAL SHALL BE INSTALLED ACCORDING TO SOUND NURSERY PRACTICES AND SHALL MEET ALL STANDARDS AS STATED IN THE LATEST EDITION OF "AMERICAN STANDARD FOR NURSERY STOCK" BY THE AMERICAN ASSOCIATION OF NURSERMEN.
- NO SUBSTITUTIONS IN PLANT MATERIALS SHALL BE MADE WITHOUT WRITTEN AUTHORIZATION FROM OWNER OR LANDSCAPE ARCHITECT. IN THE EVENT OF DISCREPANCIES BETWEEN DRAWING AND PLANT LIST, THE DRAWING SHALL PREVAIL.
- LOCATE ALL UTILITIES PRIOR TO ANY DIGGING OPERATIONS. CONTRACTOR SHALL BE RESPONSIBLE FOR ALL DAMAGES TO EXISTING UTILITIES INCURRED BY HIS WORK.
- LAY SOD FOR PROPOSED LAWN AREAS TO ALL EDGES OF PAVEMENT AND/OR LIMITS OF DISTURBANCE. THE CONTRACTOR SHALL BE RESPONSIBLE FOR THE MAINTENANCE OF ALL LANDSCAPING UNTIL FINAL ACCEPTANCE. ALL REQUIRED LANDSCAPING SHALL BE MAINTAINED IN A NEAT AND ORDERLY MANNER AT ALL TIMES. THE WORK SHALL INCLUDE, BUT NOT TO BE LIMITED TO, MOWING, EDGING, PRUNING, FERTILIZING, WATERING, WEEDING, AND OTHER SUCH ACTIVITIES COMMON TO THE MAINTENANCE OF LANDSCAPING. ALL PLANT MATERIALS SHALL BE MAINTAINED IN A HEALTHY AND GROWING CONDITION AS IS APPROPRIATE FOR THE SEASON OF THE YEAR. PLANT MATERIAL THAT DIES SHALL BE REPLACED WITH PLANT MATERIAL OF SIMILAR SIZE AND VARIETY. ALL SOD AREAS TO RECEIVE 6" DEPTH (MIN.) TOPSOIL PRIOR TO INSTALLATION. TOPSOIL SHALL BE NATURAL, FRIABLE, AND FERTILE; POSSES A pH RANGE OF 7.0-7.5; AND BE FREE OF TRASH, DEBRIS, STONES, WEEDS, AND TWIGS/BRANCHES. REFER TO SPECIFICATIONS.

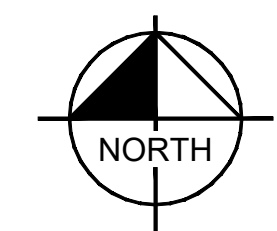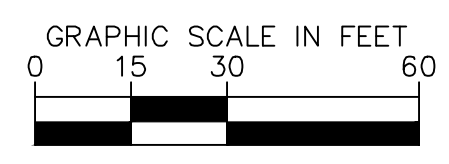

No.	REVISIONS	DATE	BY

805 PENNSYLVANIA AVENUE, SUITE 150  
 KANSAS CITY, MO 64105  
 PHONE: 816-833-8000  
 WWW.KIMLEY-HORN.COM  
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03/20/2024

KHA PROJECT	268642000
DATE	03/20/2024
SCALE: AS SHOWN	DESIGNED BY: JOK
DRAWN BY: DLL	CHECKED BY: SAR

**CP241991**  
**FRANCIS QUADRANGLE**  
 IRRIGATION, DRAINAGE,  
 AND TURF REPLACEMENT  
  
**PLANTING PLAN**  
  
 SHEET NUMBER  
**L-200**



Drawing name: K:\KNC\_LAV268642000\_MU FRANCIS QUAD.2\_DESIGN\CAD\PLANS\TSL-200 PLANTING.DWG Plot date: Friday, March 15, 2024 4:12:18 PM by: Lake, Debra Last saved: 3/15/2024 4:06 PM This document, together with the concepts and designs presented herein, is an instrument of service, intended only for the specific purpose and client for which it was prepared. Reuse of and improper reliance on this document without written authorization and adaptation by Kimley-Horn and Associates, Inc. shall be without liability to Kimley-Horn and Associates, Inc.

**SECTION 32 9210: LAWNS AND GRASSES**

**PART 1 - GENERAL**

- 1.1 SECTION INCLUDES**
- A. FURNISH ALL LABOR, MATERIAL, EQUIPMENT RELATED SERVICES AND SUPERVISION NECESSARY FOR OR INCIDENTAL TO THE INSTALLATION OF THE LAWNS AND GRASSES AS SHOWN OR INDICATED ON THE DRAWINGS AND/OR AS SPECIFIED.
  - B. WORK INCLUDED:
    1. SOIL PREPARATION AND FINE GRADING.
    2. FERTILIZATION.
    3. GRASS SODDING
    4. SEEDING
- 1.2 SUBMITTALS**
- A. DELIVERY RECEIPTS AND INVOICES: SUBMIT ORIGINAL DELIVERY RECEIPTS AND INVOICES FOR MATERIALS USED.
  - B. PRODUCT DATA: SUBMIT SAMPLE LABEL OR SPECIFICATION OF FERTILIZER.
  - C. CERTIFICATE: SUBMIT STATE CERTIFICATE STATING VARIETY AND PURITY OF GRASS SOD.
  - D. SOIL FERTILITY TEST REPORTS:
    1. SUBMIT ANALYSIS, TEST RESULTS AND CORRECTIVE RECOMMENDATIONS TO THE OWNER'S REPRESENTATIVE.
    2. ONE TEST PER MEDIAN IS REQUIRED OF EXISTING SOIL TAKEN AT DIFFERENT LOCATIONS ON THE PROJECT SITE AS DIRECTED BY THE OWNER'S REPRESENTATIVE.
- 1.3 PROTECTION**
- A. PROTECT PAVING SURFACES, CURBS, UTILITIES, PLANT MATERIALS, AND OTHER EXISTING IMPROVEMENTS FROM DAMAGE BY HEAVY EQUIPMENT.
  - B. LOCATE AND STAKE IRRIGATION HEADS, VALVE RISERS AND EQUIPMENT PRIOR TO BEGINNING SOIL PREPARATION WORK.
  - C. DURING WORK AND MAINTENANCE PERIOD, MAINTAIN TOPSOIL IN PLACE AT ESTABLISHED GRADES. REPLACE TOPSOIL AND GRASS LOSSES DUE TO EROSION.
  - D. PROTECT IN PLACE WORK FROM DAMAGE BY HEAVY EQUIPMENT. PREPARE, GRADE, LEVEL, AND REPLANT DAMAGED AREAS.
- 1.4 SUBSTANTIAL COMPLETION & PROJECT CLOSEOUT**
- A. A CERTIFICATE OF SUBSTANTIAL COMPLETION WILL BE ISSUED WHEN THE WORK PERFORMED UNDER THE CONTRACT HAS BEEN REVIEWED AND FOUND, TO THE OWNER'S REPRESENTATIVE'S BEST KNOWLEDGE, INFORMATION, AND BELIEF, TO BE SUBSTANTIALLY COMPLETE. SUBSTANTIAL COMPLETION IS THE STAGE IN THE PROGRESS OF THE WORK WHEN THE WORK OR DESIGNATED PORTION THEREOF IS SUFFICIENTLY COMPLETE IN ACCORDANCE WITH THE CONTRACT DOCUMENTS SO THE OWNER CAN OCCUPY OR UTILIZE THE WORK FOR ITS INTENDED USE. THE DATE OF SUBSTANTIAL COMPLETION OF THE PROJECT OR PORTION THEREOF IS ALSO THE DATE OF COMMENCEMENT OF APPLICABLE WARRANTIES AS SPECIFIED.
  - B. A LIST OF ITEMS TO BE COMPLETED OR CORRECTED WILL BE ATTACHED TO THE CERTIFICATE OF SUBSTANTIAL COMPLETION. THE FAILURE TO INCLUDE ANY ITEMS ON SUCH LIST DOES NOT ALTER THE RESPONSIBILITY OF THE CONTRACTOR TO COMPLETE ALL WORK IN ACCORDANCE WITH THE CONTRACT DOCUMENTS.
  - C. THE CONTRACTOR WILL COMPLETE OR CORRECT THE WORK ON THE LIST OF ITEMS WITHIN A SPECIFIC NUMBER OF DAYS AS SHOWN ON THE CERTIFICATE OF SUBSTANTIAL COMPLETION.
  - D. UPON COMPLETION AND RE-INSPECTION OF ALL CORRECTED ITEMS LISTED, THE OWNER'S REPRESENTATIVE WILL RECOMMEND TO THE OWNER THAT THE WORK OF THIS SECTION IS READY FOR FINAL ACCEPTANCE.
- 1.5 QUALITY ASSURANCE**
- A. GENERAL: COMPLY WITH APPLICABLE FEDERAL, STATE, COUNTY AND LOCAL REGULATIONS GOVERNING LANDSCAPE MATERIALS AND WORK.
  - B. PERSONNEL: EMPLOY ONLY EXPERIENCED PERSONNEL WHO ARE FAMILIAR WITH THE REQUIRED WORK. PROVIDE SUPERVISION BY A QUALIFIED FOREMAN.
- 1.6 GUARANTEE**
- A. GUARANTEE LAWNS AND GRASSES FOR ONE YEAR AFTER DATE OF FINAL ACCEPTANCE AT THE END OF THIS GUARANTEE PERIOD, ALL LAWN AND GRASS AREAS WILL HAVE ACHIEVED COVERAGE OF THE SPECIFIED GRASS AT A DENSITY OF 100% COVERAGE, FREE OF WEEDS, UNDESIRABLE GRASS SPECIES, DISEASE, AND INSECTS. REPLACE DEAD MATERIALS AND MATERIALS NOT IN VIGOROUS, THRIVING CONDITION AS SOON AS WEATHER PERMITS AND ON NOTIFICATION BY THE OWNER'S REPRESENTATIVE.
  - B. REPLACE LAWNS AND GRASSES WITH SAME KIND AS ORIGINALLY PLANTED, AT NO COST TO THE OWNER. PROTECT IRRIGATION SYSTEM AND OTHER PIPING, CONDUIT, OR OTHER WORK DURING REPLACEMENT. REPAIR DAMAGE IMMEDIATELY.
- 1.7 JOB CONDITIONS**
- A. DO NOT INSTALL SOD OR SEED ON SATURATED OR FROZEN SOIL.
  - B. SOD AND SEED INSTALLATION SHALL BE SUBJECT TO SUITABILITY OF THE WEATHER AND OTHER CONDITIONS AFFECTING SOD GROWTH.
- 1.8 PROGRESS MEETINGS**
- A. CONTRACTOR SHALL ATTEND ALL PROGRESS MEETINGS AS REQUESTED BY THE OWNER'S REPRESENTATIVE DURING INSTALLATION.
- 1.9 QUANTITY VERIFICATION**
- A. THE BIDDING CONTRACTOR IS RESPONSIBLE FOR THE INCLUSION OF ALL MATERIALS, LABOR AND EQUIPMENT AS OUTLINED IN THE PLANS AND SPECIFICATION. THE PLANT LIST IS PROVIDED TO THE BIDDING CONTRACTOR AS A CONVENIENCE AND THE QUANTITIES ARE APPROXIMATE. VERIFICATION OF ALL QUANTITIES IS THE SOLE RESPONSIBILITY OF THE BIDDING CONTRACTOR. ANY DISCREPANCIES MUST BE REPORTED TO THE OWNER'S REPRESENTATIVE PRIOR TO SUBMITTAL OF BID.

**PART 2 PRODUCTS**


- 2.1 GRASS**
- A. GENERAL:
    1. SOD SHALL BE NURSERY GROWN ON CULTIVATED AGRICULTURAL SOILS. SOD SHALL HAVE BEEN MOWED REGULARLY AND CAREFULLY AND OTHERWISE MAINTAINED FROM PLANTING TO HARVEST.
    2. SOD SHALL BE OF SPECIES INDICATED.
    3. THICKNESS OF CUT: SOD SHALL BE CUT TO THE SUPPLIER'S STANDARD WIDTH AND LENGTH. MAXIMUM ALLOWABLE DEVIATION FROM STANDARD WIDTHS AND LENGTHS SHALL BE PLUS OR MINUS .25 INCHES ON WIDTH AND PLUS OR MINUS 5% ON LENGTH.
    4. BROKEN STRIPS AND TORN OR UNWORN ENDS WILL NOT BE ACCEPTED.
    5. STRENGTH OF SOD STRIPS: SOD STRIPS SHALL BE STRONG ENOUGH TO SUPPORT THEIR OWN WEIGHT AND RETAIN THEIR SIZE AND SHAPE IF SUSPENDED VERTICALLY WHEN GRASPED IN THE UPPER 10% OF THE SECTION.
    6. MOISTURE CONTENT: SOD SHALL NOT BE HARVESTED OR TRANSPORTED WHEN MOISTURE CONTENT (EXCESSIVELY WET OR DRY) MAY ADVERSELY AFFECT ITS SURVIVAL. SOD SHALL BE STORED IN A COMPACT GROUP TO PREVENT DRYING OUT OR FREEZING.
    7. TIME LIMITATIONS: SOD SHALL BE HARVESTED, DELIVERED, AND TRANSPLANTED WITHIN A 30-HOUR PERIOD UNLESS A SUITABLE PRESERVATION METHOD IS APPROVED BY THE OWNER'S REPRESENTATIVE PRIOR TO DELIVERY. SOD NOT TRANSPLANTED WITHIN THIS PERIOD SHALL BE INSPECTED FOR APPROVAL BY THE OWNER'S REPRESENTATIVE PRIOR TO ITS INSTALLATION.
    8. THATCH: SOD SHALL BE FREE OF THATCH.
    9. DISEASES, NEMATODES AND INSECTS: SOD SHALL BE FREE OF DISEASES, NEMATODES, AND SOIL-BORNE INSECTS.
    10. WEEDS: SOD SHALL BE FREE OF OBJECTIONABLE GRASSY AND BROADLEAF WEEDS.
  - B. SOD:
    1. BLACK BEAUTY TALL FESCUE (UNNETTED)
- 2.2 TOPSOIL**
- A. GENERAL TOPSOIL
    1. ALL TOPSOIL MATERIALS SHALL BE STRIPPED AND REDISTRIBUTED ON-SITE AS DESCRIBED HEREIN. STOCKPILING OF TOPSOIL MATERIAL SHALL NOT LAST LONGER THAN 60 DAYS, AND TOPSOIL STOCKPILE HEIGHT SHALL NOT EXCEED 60 INCHES. ALL EXISTING TURF, ROCK, AND OTHER DELETERIOUS MATERIALS GREATER THAN TWO INCHES (2") IN DIAMETER SHALL BE REMOVED FROM THE TOPSOIL TO ACCOMMODATE THE INSTALLATION OF SOIL PREP MATERIALS
- 2.4 COMPOST**
- A. GENERAL COMPOST
    1. ALL COMPOST MATERIAL SHOULD BE OBTAINED THROUGH THE CITY OF COLUMBIA OR APPROVED EQUAL SUPPLIER. PROVIDE A CURRENT COMPOSTING ANALYSIS REPORT TO BE APPROVED BY THE OWNER PRIOR TO INSTALLATION.
- 2.5 FERTILIZER**
- A. GENERAL:
    1. FERTILIZER SHALL BE COMMERCIAL PRODUCT, UNIFORM IN COMPOSITION, FREE FLOWING, AND SUITABLE FOR APPLICATION WITH APPROVED EQUIPMENT.
    2. DELIVER FERTILIZER TO SITE IN FULLY LABELED ORIGINAL CONTAINERS.
    3. FERTILIZER WHICH HAS BEEN EXPOSED TO HIGH HUMIDITY AND MOISTURE HAS BECOME CAKED OR OTHERWISE DAMAGED, MAKING IT UNSUITABLE FOR USE, WILL NOT BE ACCEPTABLE.
  - B. APPLICATION: AS DETERMINED IN SOIL TESTING ANALYSIS AS DESCRIBED HEREIN

**PART 3 EXECUTION**

- 3.1 GENERAL**
- A. EXECUTE GRASS PLANTING OPERATIONS ACROSS SLOPE AND PARALLEL TO FINISHED GRADE CONTOURS.
- 3.2 PRE-PLANT WEED CONTROL**
- A. IRRIGATED AND NON-IRRIGATED GRASS AREAS:
    1. IF GRASSY OR BROADLEAF WEEDS EXIST ON SITE AT THE BEGINNING OF WORK, SPRAY WITH A NON-SELECTIVE SYSTEMIC CONTACT HERBICIDE, AS RECOMMENDED AND APPLIED BY AN APPROVED LICENSED LANDSCAPE PEST CONTROL ADVISOR AND APPLICATOR. LEAVE SPRAYED PLANTS INTACT FOR AT LEAST 15 DAYS TO ALLOW SYSTEMIC KILL.
    2. CLEAR AND REMOVE THESE EXISTING WEEDS BY MOWING OR GRUBBING OFF ALL PLANT PARTS AT LEAST 0.25 INCHES BELOW THE SURFACE OF THE SOIL OVER THE ENTIRE AREA TO BE PLANTED.
  - B. IRRIGATED GRASS AREAS ONLY:
    1. AFTER IRRIGATION SYSTEM IS OPERATIONAL, APPLY WATER FOR 5 TO 10 DAYS AS NEEDED TO ACHIEVE WEED GERMINATION. APPLY CONTACT HERBICIDES AND WAIT AS NEEDED BEFORE PLANTING. REPEAT AS NEEDED.
    2. MAINTAIN LAWN AND GRASS AREAS WEED FREE UNTIL FINAL ACCEPTANCE BY OWNER'S REPRESENTATIVE UTILIZING MECHANICAL AND CHEMICAL TREATMENT.
- 3.3 SOIL PREPARATION**
- A. GRADING:
    1. CUT AND FILL ALL AREAS TO ELEVATIONS AND TOLERANCES SPECIFIED. LEAVE GRADED SURFACE CLEAN, FREE FROM RUBBISH AND LARGE CLODS AND REASONABLE SMOOTH.
    2. ROOTS FROM PREVIOUSLY-REMOVED TREES MAY BE ENCOUNTERED AND SHOULD BE REMOVED IF THEY ARE WITHIN 6" OF FINISHED GRADE ELEVATIONS. BRICKS, BUILDING STONE, OR OTHER BUILDING MATERIALS SHALL ALSO BE REMOVED FROM TOP 6" OF SOIL PROFILE.
    3. COMPOST SHALL BE REVERSE TINE TILLED INTO THE EXISTING TOPSOILS AS FOLLOWS: ADD THREE CUBIC YARDS PER 1,000 SQUARE FEET OF SODDED AREA. SPREAD EVENLY TO THE ROUGH GRADED SURFACE AND REVERSE TINE TILL TO A DEPTH OF 6".
    4. FINISH GRADE AND COMPACT SOILS PER THIS SPECIFICATION.
    5. AFTER FINISH GRADES HAVE BEEN SET, COORDINATE WITH OWNER FOR APPROVAL PRIOR TO SOD INSTALLATION. OWNER WITH CONTRACT WITH A THIRD-PARTY SURVEYOR TO CONFIRM GRADES MATCH PLANS AS REQUIRED.
  - B. COMPACTION:
    1. COMPACT SUBGRADE AND EACH LAYER OF TOPSOIL TO PROVIDE SOIL MASS WITH DENSITIES NOT LESS THAN THE VALUES SPECIFIED BELOW. PERFORM COMPACTION USING EQUIPMENT AND METHODS AS NEEDED TO PRODUCE A SOIL MASS WITH SPECIFIED DENSITIES WITHOUT DAMAGE TO EXISTING STRUCTURES.
    2. DENSITY REQUIREMENTS: DETERMINE MAXIMUM DRY DENSITY OF SOIL IN ACCORDANCE WITH ASTM D698. COMPACT SOIL DRY DENSITIES TO NOT LESS THAN 98% IN UTILITY TRENCH BACKFILL AREAS AND 92% IN FINISH GRADE FOR LAWNS (TOP 6"). DETERMINE DENSITY OF IN-PLACE MATERIAL IN ACCORDANCE WITH ASTM D1556 OR D938.
    3. MOISTURE CONTROL: BEFORE COMPACTION, MOISTEN OR AERATE SUBGRADE AND EACH LAYER OF FILL/BACKFILL AS NECESSARY TO BRING THE MOISTURE CONTENT OF THE SOIL TO BE COMPACTED TO ITS OPTIMUM MOISTURE CONTENT. DETERMINE OPTIMUM MOISTURE CONTENT IN ACCORDANCE WITH ASTM D698.
  - C. FINE GRADING:
    1. AFTER TILLAGE AND PLACEMENT OF TOPSOIL, LEVEL, FINE GRADE, AND DRAG WITH A WEIGHTED SPIKE HARROW OR FLOAT DRAG.
    2. ELIMINATE RUTS, DEPRESSIONS, HUMPS, AND OBJECTIONABLE SOIL CLODS.
- 3.4 SOIL TESTING AND FERTILIZING**
- A. GENERAL: AFTER PLACEMENT OF TOPSOIL BUT PRIOR TO PLACEMENT OF SOD, PERFORMANCE OF FOUR SOIL TESTS SHALL BE COMPLETED. TWO SAMPLES SHALL BE COLLECTED FROM RE-GRADED LAWN IN THE SOUTH HALF OF FRONDS QUAD, AND TWO SAMPLES SHALL BE COLLECTED FROM THE NORTH HALF OF THE LAWN WHERE EARTHWORK OPERATIONS ARE NOT TO OCCUR AS A PART OF THIS PROJECT. ALL SAMPLES SHALL BE SUBMITTED TO THE UNIVERSITY OF MISSOURI EXTENSION OFFICES AT THE CONTRACTOR'S EXPENSE FOR REGULAR SOIL ANALYSIS. A DETERMINATION OF ANY ADDITIONAL SOIL AMENDMENTS OR FERTILIZATION REQUIREMENTS WILL BE MADE AFTER REVIEW OF THE RESULTS.
  - B. THE FERTILIZER TYPES AND RATES SHALL BE DETERMINED BY THE SOIL FERTILITY TEST CORRECTIVE RECOMMENDATIONS, BUT ARE INCLUDED IN THE CONTRACTOR'S BASE BID, AS DESCRIBED HEREIN.
  - C. TYPICAL SOD FERTILIZATION SCHEDULE:
    1. INITIAL APPLICATION: APPLY NO MORE THAN 5 DAYS PRIOR TO COMMENCEMENT OF SODDING OPERATIONS AT A RATE OF 20 POUNDS PER 1,000 SQUARE FEET. INCORPORATE INTO SOIL WITH A CHAIN HARROW.
    2. SECOND AND THIRD APPLICATIONS: APPLY EVERY 25 DAYS AFTER SODDING AT A RATE OF 10 POUNDS PER 1,000 SQUARE FEET.
    3. IRRIGATE THE AREA WITH A MINIMUM OF .25 INCHES OF WATER TO PROPERLY INCORPORATE THE FERTILIZER INTO THE TURF.
- 3.5 PLANTING SOD**
- A. WEATHER CONDITIONS:
    1. SCHEDULE WORK FOR PERIODS OF FAVORABLE WEATHER.
    2. SOD PLACEMENT ON DAYS WHICH, IN THE JUDGMENT OF THE OWNER'S REPRESENTATIVE, ARE TOO HOT, COLD, SUNNY, DRY, OR WINDY FOR OPTIMAL INSTALLATION MAY BE PROHIBITED.
  - B. PLACEMENT PATTERN:
    1. THE FIRST ROW SHALL BE LAID IN A STRAIGHT LINE WITH SUBSEQUENT ROWS PARALLEL TO THE FIRST ROW AND TIGHTLY ABUTTING EACH OTHER.
    2. LATERAL JOINTS SHALL BE STAGGERED. CARE SHALL BE EXERCISED TO ENSURE THAT THE SOD IS NEITHER STRETCHED NOR OVERLAPPED. JOINTS MUST BE BUTTED TIGHTLY TO PREVENT VOIDS THAT COULD PERMIT AIR TO DRY OUT ROOT.
    3. IMMEDIATELY AFTER PLACING, SOD SHALL BE PRESSED FIRMLY INTO CONTACT WITH BED BY TAMPING OR ROLLING TO ELIMINATE AIR POCKETS. FOLLOWING TAMPING, SCREENED TOPSOIL SHALL BE USED TO FILL ALL CRACKS AND EXCESS SOIL SHALL BE WORKED INTO THE SOD WITH RAKES OR OTHER SUITABLE EQUIPMENT. SOD SHALL NOT BE SMOOTHED WITH EXCESS FILL SOIL.
    4. ON SLOPES STEEPER THAN 3 TO 1, SOD SHALL BE SECURED BY GALVANIZED PINS, WOOD PEGS OR OTHER METHODS APPROVED BY THE OWNER'S REPRESENTATIVE.
    5. IMMEDIATELY AFTER SODDING OPERATIONS HAVE BEEN COMPLETED, THE ENTIRE SURFACE SHALL BE COMPACTED WITH A ROLLER OR OTHER APPROVED EQUIPMENT. THE COMPLETED AREA AFTER SODDING SHALL BE UNIFORMLY EVEN, FIRM, AND TRUE TO FINISHED GRADE LINES.
  - C. WATERING:
    1. INITIAL INSTALLATION: WATER MUST BE APPLIED WITHIN 2 HOURS OF EXPOSURE OF THE SOD TO SUN OR WIND. WATER NEWLY LAD SOD UNTIL SATURATION OF THE ENTIRE AREA IS APPARENT. AS A RESULT OF INITIAL IRRIGATION, STANDING WATER MAY BE PRESENT AND MODERATE TO HEAVY RUN OFF MAY OCCUR. CONTINUE TO IRRIGATE DAILY IN SHORTER DURATIONS SO THE ENTIRE AREA STAYS THOROUGHLY WET BUT WITHOUT STANDING WATER. THE LENGTH OF IRRIGATION TIME AND FREQUENCY OF APPLICATIONS WILL VARY AT DIFFERENT LOCATIONS DUE TO WEATHER CONDITIONS AND INDIVIDUAL SITE CHARACTERISTICS.
    2. AFTER 7 TO 10 DAYS: CHECK FOR NEW ROOT GROWTH BY LIFTING CORNERS OF SOD BLOCKS. IF CONSISTENT ROOT GROWTH OVER THE ENTIRE SITE IS OBSERVED, WATER APPLICATIONS CAN BE REDUCED TO ONCE EVERY OTHER DAY.
    3. AFTER 12 TO 14 DAYS: RECHECK FOR ADDITIONAL ROOTING. IF SOD BLOCKS ARE DIFFICULT TO PULL UP OR ADDITIONAL NEW ROOTS ARE PRESENT ALLOW THE AREA TO DRY TO THE EXTENT THAT MOWING CAN BE PERFORMED.
- 3.7 GRADING**
- A. MAINTAIN EXISTING ESTABLISHED GRADES, PROTECT TRUE AND EVEN DURING OPERATIONS.
- 3.8 EROSION CONTROL**
- A. DURING WORK AND MAINTENANCE PERIOD, MAINTAIN TOPSOIL IN PLACE AT ESTABLISHED GRADES. REPLACE TOPSOIL AND TURF GRASS LOSSES DUE TO EROSION.
- 3.9 CLEAN-UP**
- A. REMOVE EXCESS MATERIAL AND DEBRIS FROM SITE.
- 3.10 MAINTENANCE**
- A. PROTECTION OF GRADED AREAS: PROTECT NEWLY GRADED AREAS FROM TRAFFIC AND EROSION. KEEP FREE OF TRASH AND DEBRIS. REPAIR AND RE-ESTABLISH GRASSES IN SETTLED, ERODED, AND RUTTED AREAS.
  - B. RECONDITIONING OF COMPACTED AREAS: WHERE COMPLETED COMPACTED AREAS ARE DISTURBED BY SUBSEQUENT CONSTRUCTION OPERATIONS OR ADVERSE WEATHER, SCARIFY THE SURFACE, RE-SHAPE, AND COMPACT TO REQUIRED DENSITY PRIOR TO FURTHER CONSTRUCTION.
  - C. SETTLING: WHERE SETTLING IS MEASURABLE OR OBSERVABLE AT BACKFILLED OR FILLED AREAS DURING THE GENERAL PROJECT WARRANTY PERIOD, REMOVE SOD, ADD APPROPRIATE BACKFILL MATERIAL, COMPACT, AND REPLACE SOD. RESTORE APPEARANCE, QUALITY, AND CONDITION OF SURFACE TO MATCH ADJACENT WORK AND ELIMINATE EVIDENCE OF RESTORATION TO GREATEST EXTENT POSSIBLE.
  - D. UNTIL FINAL ACCEPTANCE, MAINTAIN LAWN AND GRASS AREAS BY WATERING, MOWING, WEEDING, SPRAYING, CLEANING AND REPLACING AS NECESSARY TO KEEP THE TURF AND GRASS IN A VIGOROUS, HEALTHY CONDITION.
    1. WATERING: AS NECESSARY.
    2. MOWING:
      - a) MOW NEWLY PLANTED GRASS AREAS WEEKLY AFTER INITIAL GROWTH REACHES 1.5 TO 2 INCHES.
    3. WEEDING: REMOVE WEEDS AND FOREIGN GRASS OVER LAWN AND GRASS AREAS AT LEAST ONCE A WEEK. HERBICIDES MAY BE USED ONLY WHEN APPROVED BY THE OWNER'S REPRESENTATIVE.

END OF SECTION 329210


**C SOD PROFILE**  
3/4" = 1'-0"

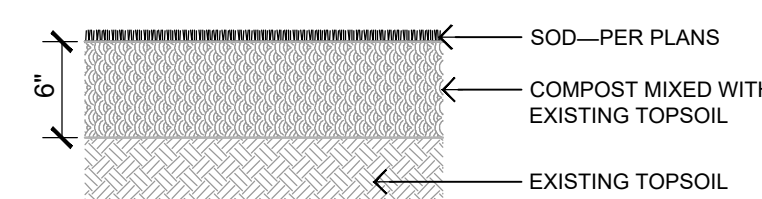


NOTE:

1. STRIP AND STOCKPILE TOP 6" OF EXISTING TOPSOIL PER PLANS AND SPECIFICATIONS.
2. PLACE 6" OF TOPSOIL AND MIX IN COMPOST PER SPECIFICATIONS.


**B TYPICAL TRUNK PROTECTION**  
1/4" = 1'

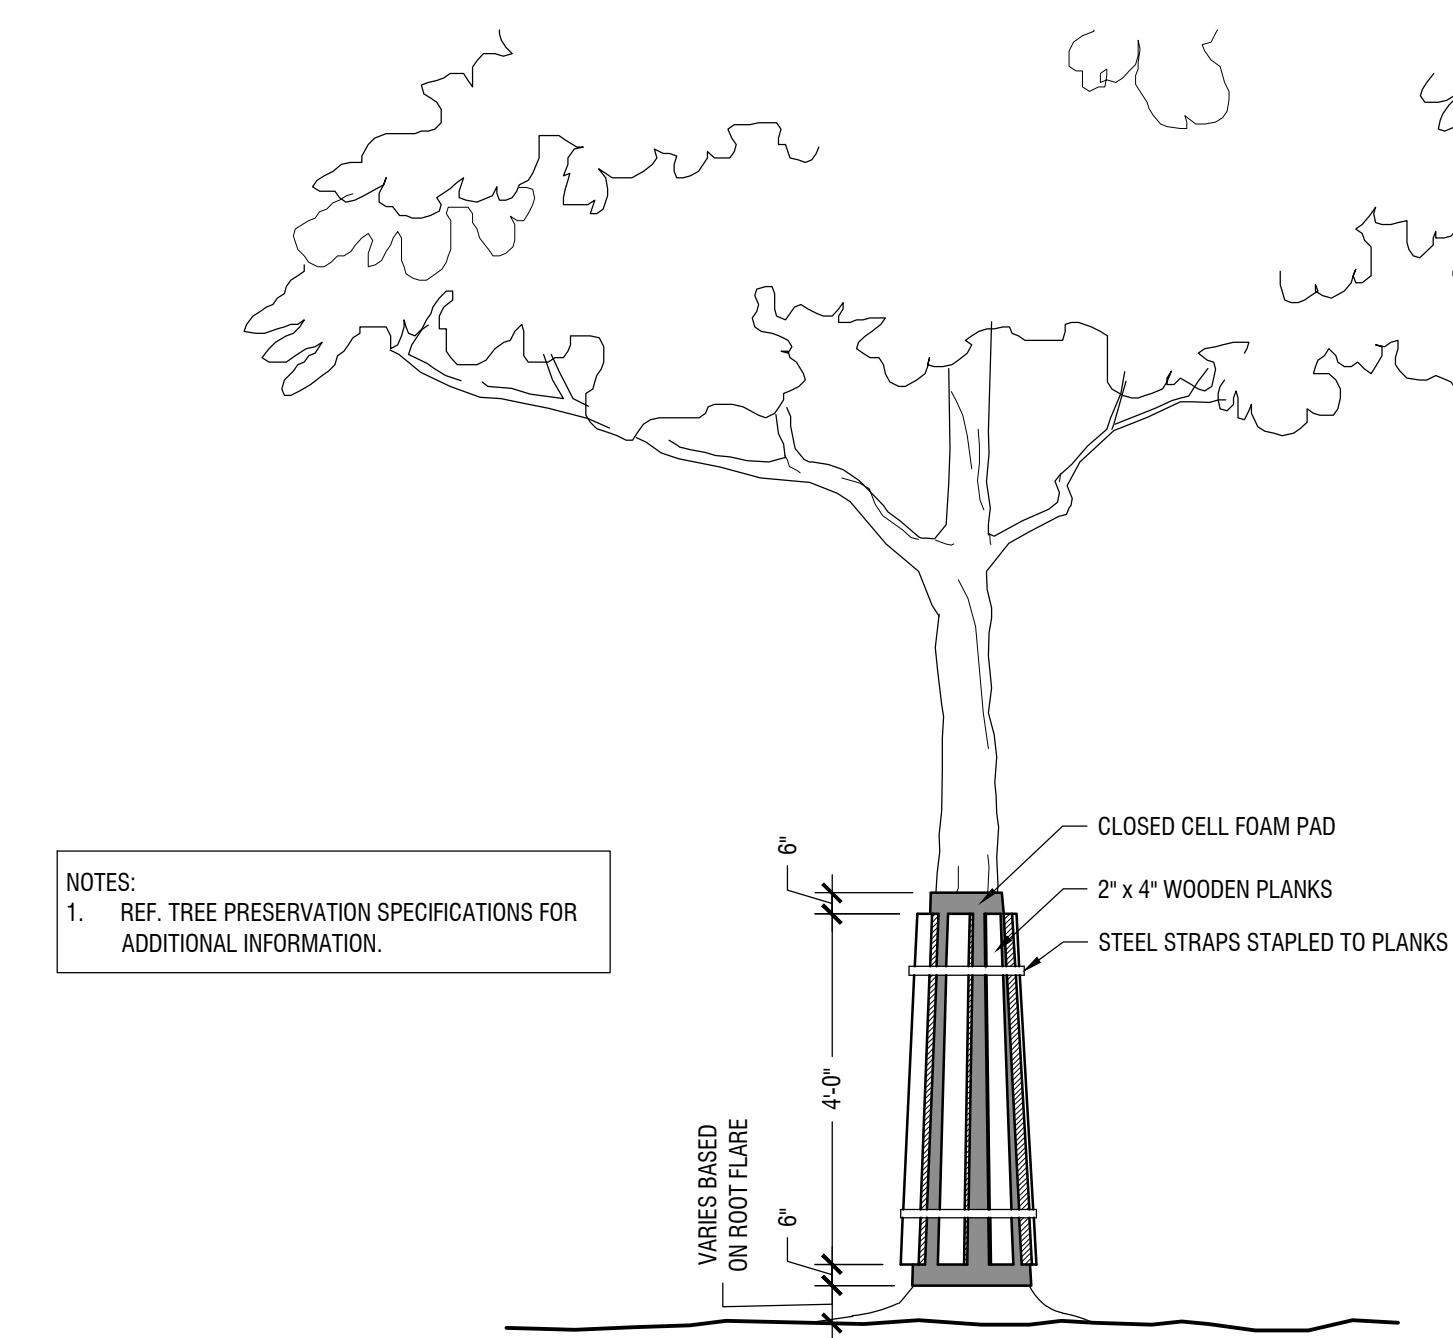

TREE PROTECTION SIGN ENLARGEMENT

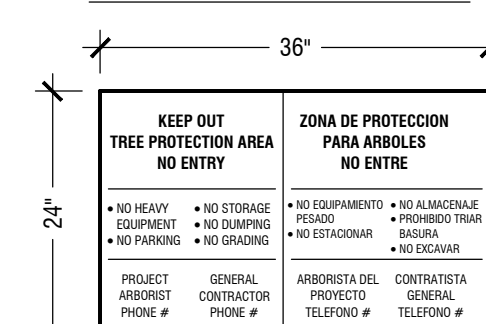

- NOTES:
1. SEE SPECIFICATIONS FOR WATERING AND OTHER ADDITIONAL REQUIREMENTS.
  2. ALL TREE AND ROOT PRUNING SHALL BE COMPLETED BY OWNER'S REPRESENTATIVE.
  3. NO EQUIPMENT SHALL OPERATE INSIDE THE TREE PROTECTION FENCE INCLUDING DURING FENCE INSTALLATION AND REMOVAL.
  4. FINAL LOCATION OF TREE PROTECTION FENCING SHALL BE COORDINATED WITH AND APPROVED BY THE PROJECT ARBORIST.
  5. TREE PROTECTION FENCE LAYOUT AND INSTALLATION TO BE APPROVED BY PROJECT ARBORIST PRIOR TO ANY CONSTRUCTION ACTIVITY.

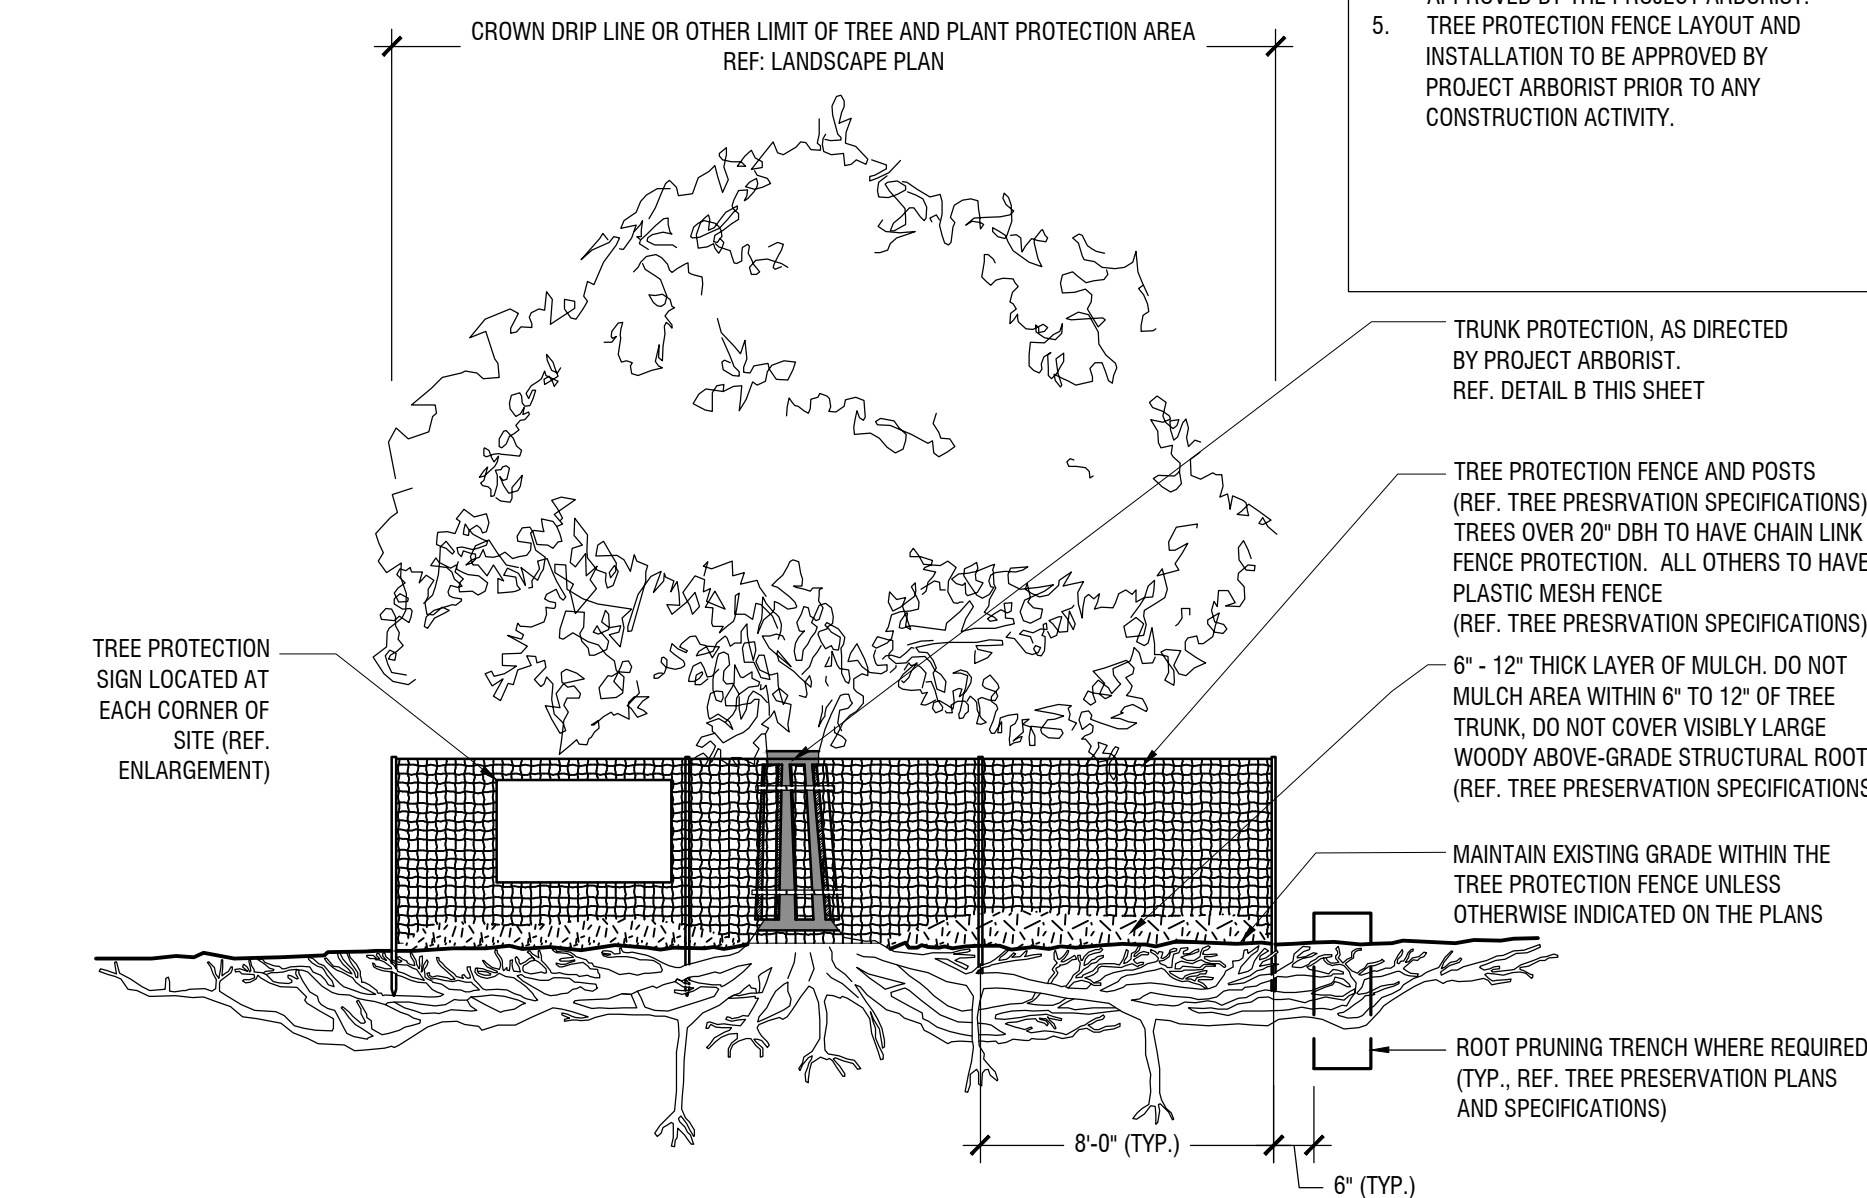

**A TYPICAL TREE PROTECTION FENCING**  
1/4" = 1'

NO.	REVISIONS	DATE	BY

**Kimley & Horn**  
805 PENNSYLVANIA AVENUE, SUITE 150  
KANSAS CITY, MO 64105  
PH: 816.234.6300  
WWW.KIMLEY-HORN.COM  
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MO CERTIFICATE OF AUTHORITY #001512, EXPIRES 12/31/22

SEAN ALBERT  
RAY  
NUMBER  
LA-2012026597  
3/20/2024

KHA PROJECT 268642000	DATE 03/20/2024	SCALE: AS SHOWN	DESIGNED BY: JOK	DRAWN BY: DLL	CHECKED BY: SAR
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**PLANTING DETAILS + SPECIFICATIONS**



**CP24 1991 FRANCIS QUADRANGLE IRRIGATION, DRAINAGE, AND TURF REPLACEMENT**



Drawing name: K:\KNC\_LA\268642000\_MU FRANCIS QUAD2. DESIGN\CAD\PLANS\IRRI\300 IRRIGATION.DWG Plot date: Friday, March 15, 2024 4:12:27 PM by: Lake, Debra Last saved: 3/15/2024 4:10 PM  
This document, together with the concepts and designs presented herein, is intended only for the specific purpose and client for which it was prepared. Reuse of and improper reliance on this document without written authorization and adaptation by Kimley-Horn and Associates, Inc. shall be without liability to Kimley-Horn and Associates, Inc.

**IRRIGATION SCHEDULE**

SYMBOL	MANUFACTURER/MODEL/DESCRIPTION	QTY
	HUNTER I-20-04 1.5 TURF ROTOR, 4IN. POP-UP, ADJUSTABLE AND FULL CIRCLE. PLASTIC RISER, DRAIN CHECK VALVE, STANDARD NOZZLE.	8
	HUNTER I-20-04 2.5 TURF ROTOR, 4IN. POP-UP, ADJUSTABLE AND FULL CIRCLE. PLASTIC RISER, DRAIN CHECK VALVE, STANDARD NOZZLE.	3
	HUNTER I-20-04 3.0 TURF ROTOR, 4IN. POP-UP, ADJUSTABLE AND FULL CIRCLE. PLASTIC RISER, DRAIN CHECK VALVE, STANDARD NOZZLE.	54
	HUNTER I-20-04 5.0 TURF ROTOR, 4IN. POP-UP, ADJUSTABLE AND FULL CIRCLE. PLASTIC RISER, DRAIN CHECK VALVE, STANDARD NOZZLE.	56
SYMBOL	MANUFACTURER/MODEL/DESCRIPTION	QTY
	HUNTER BV-FS 1IN., 1-1/2IN., 2IN., AND 3IN. BRASS ELECTRIC REMOTE CONTROL VALVE, GLOBE CONFIGURATION, WITH NPT THREADED INLET/OUTLET, FOR COMMERCIAL/MUNICIPAL USE. WITH FILTER SENTRY FACTORY INSTALLED OPTION.	22
	LANDSCAPE PRODUCTS INC. BBV 1/2IN., 3/4IN., 1IN., 1-1/4IN., 1-1/2IN., 2IN., 2-1/2IN., 3IN. FULL PORT BRASS BALL VALVE. SUITABLE FOR A FULL RANGE OF LIQUIDS AND GASES IN RESIDENTIAL AND COMMERCIAL APPLICATIONS.	1
	HUNTER BV 3" 1IN., 1-1/2IN., 2IN., AND 3IN. BRASS ELECTRIC MASTER VALVE, GLOBE CONFIGURATION, WITH NPT THREADED INLET/OUTLET, FOR COMMERCIAL/MUNICIPAL USE.	1
	HUNTER A2C-750-M 75-STATION DECODER CONTROLLER IN AN OUTDOOR GRAY METAL WALL MOUNT ENCLOSURE.	1
	POINT OF CONNECTION 3"	1
	IRRIGATION LATERAL LINE: PVC SCHEDULE 40	4,531 L.F.
	IRRIGATION MAINLINE: PVC SCHEDULE 40	758.5 L.F.

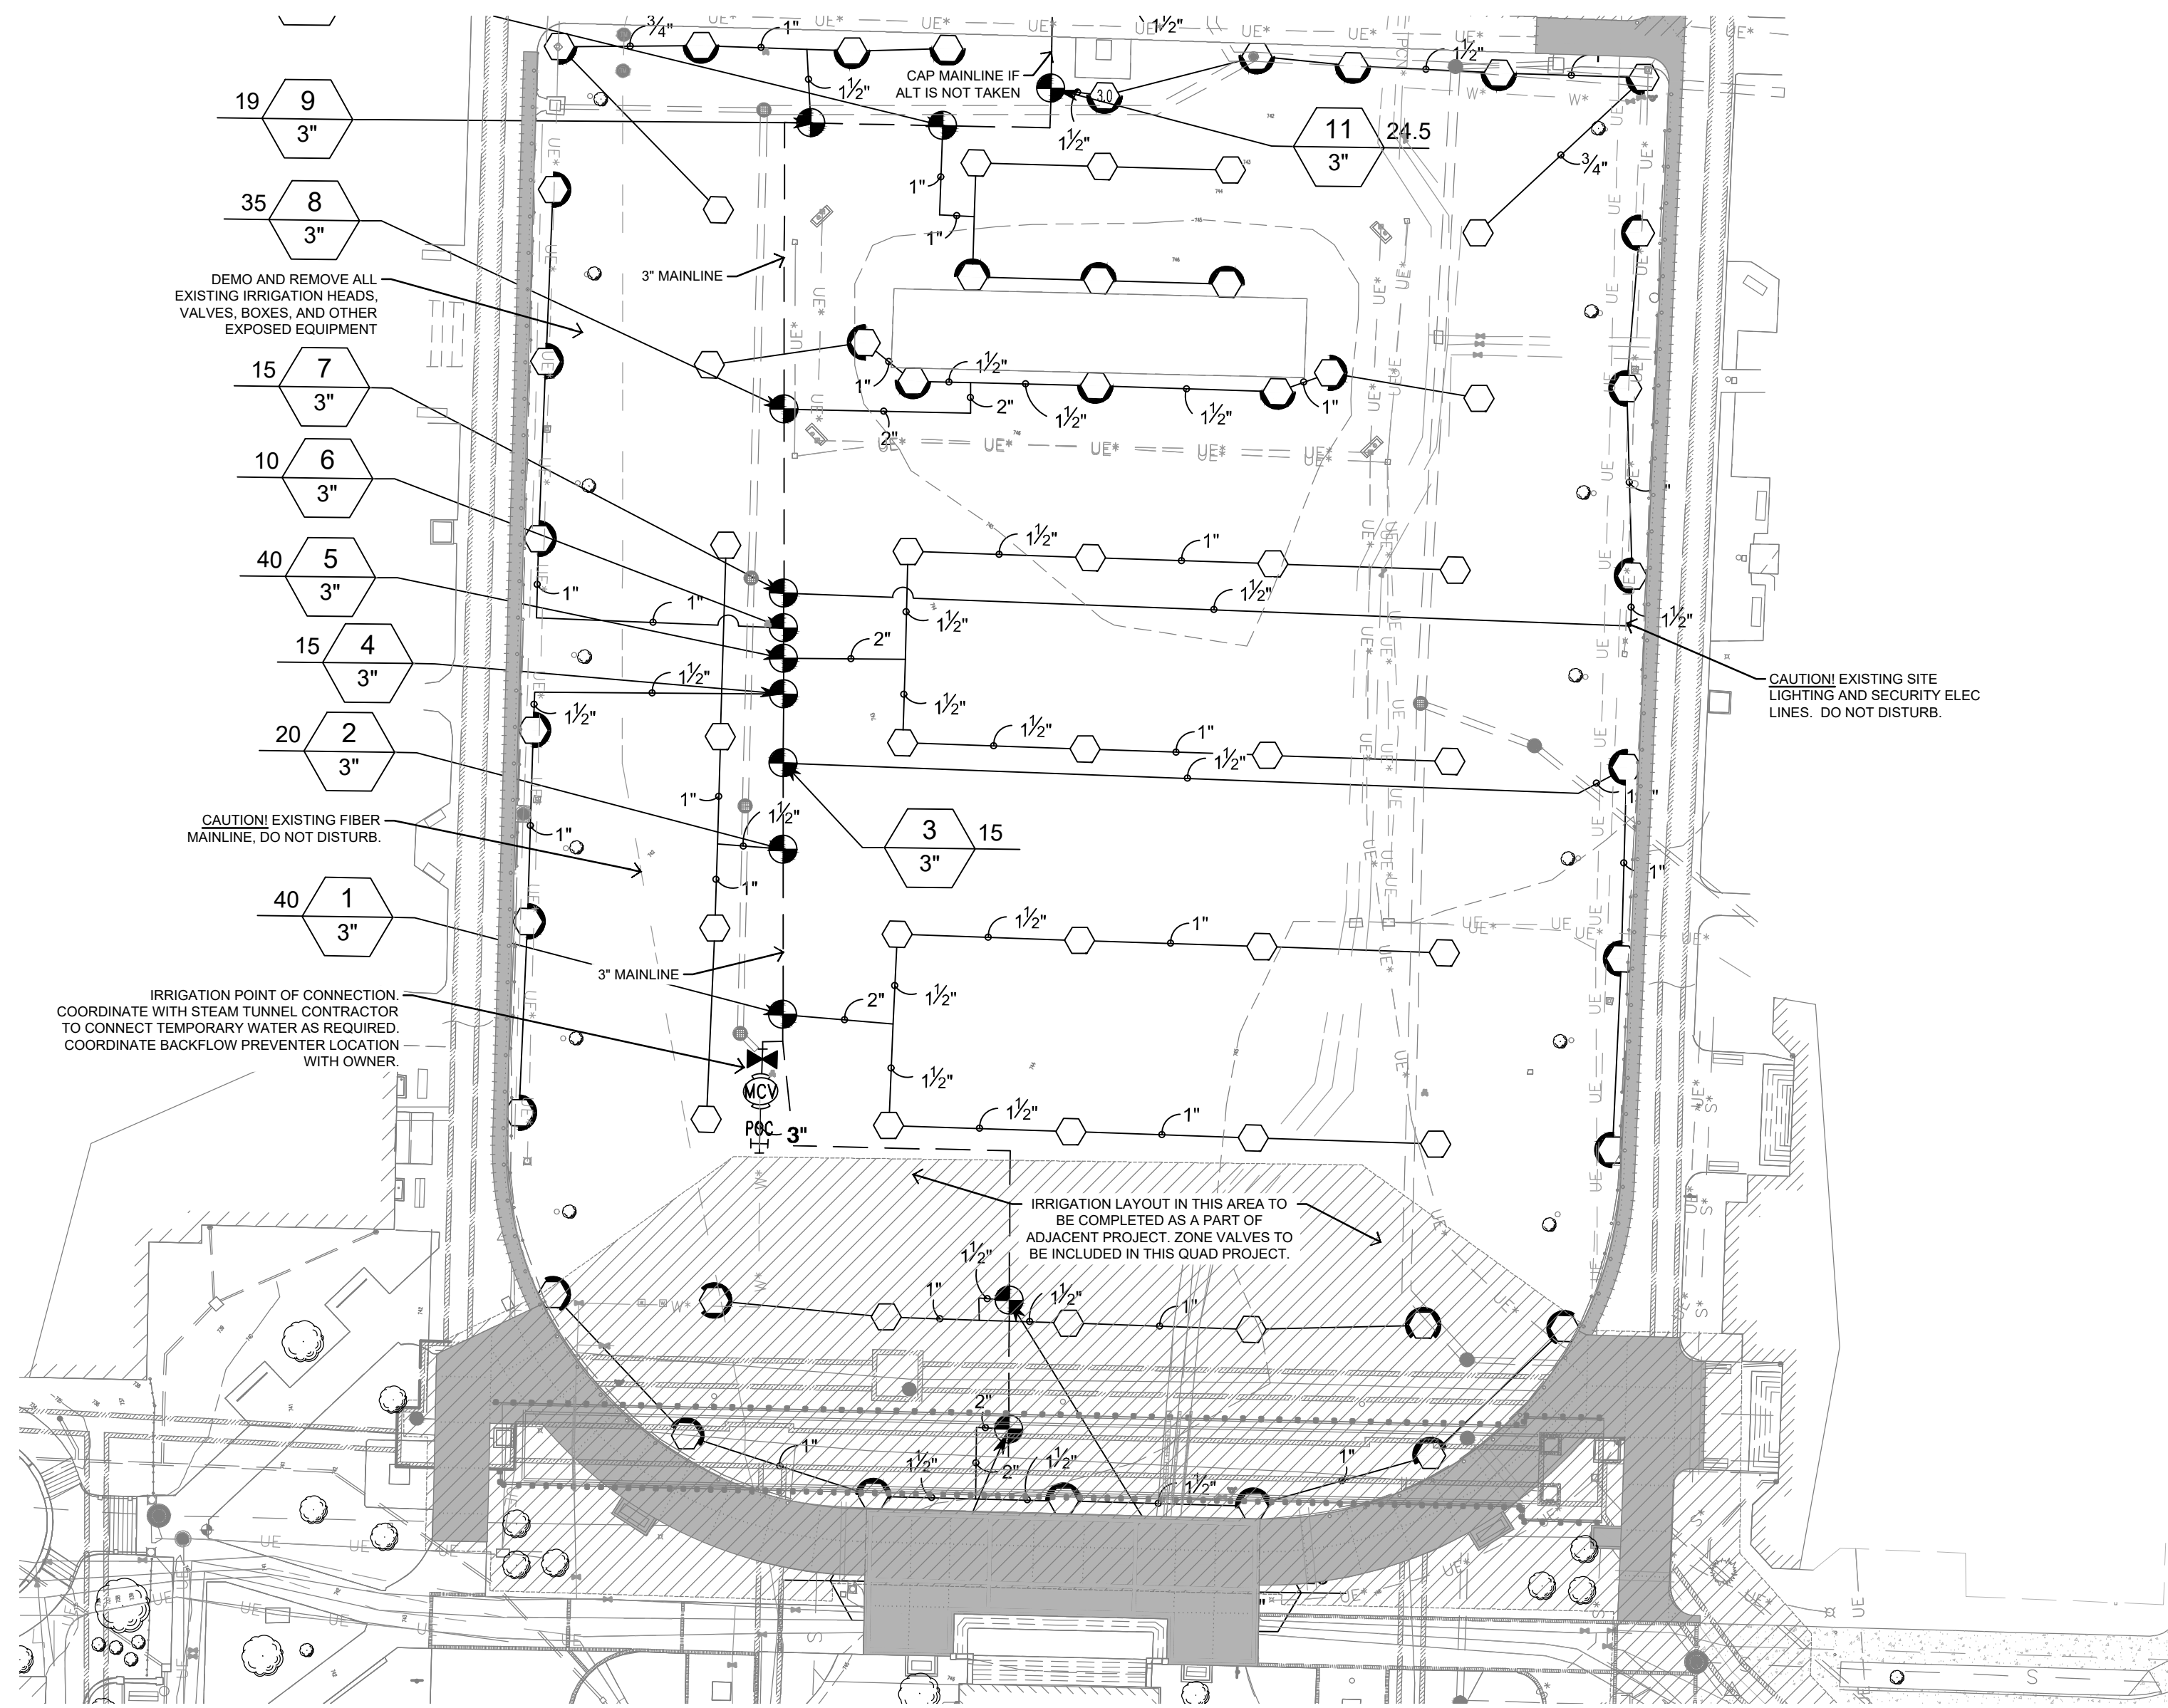
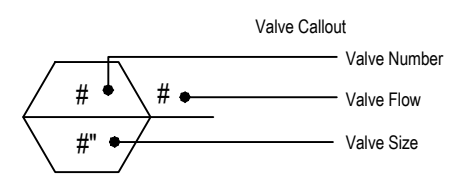


**EXISTING IRRIGATION NOTES:**

- CONTRACTOR TO CONFIRM EXISTING SYSTEM SOURCE AND BACKFLOW ARE FULLY OPERATIONAL. COORDINATE TEMPORARY WATER CONNECTIONS WITH STEAM TUNNEL PROJECT AS REQUIRED.
- CONTRACTOR TO CONFIRM EXISTING BACKFLOW IS TO SERVE IRRIGATION SYSTEM ONLY. EXISTING BACKFLOW MUST BE PLACED ON IRRIGATION SERVICE LINE TO PREVENT ANY POSSIBILITY OF BACKFLOW FROM BEING DIRECTED INTO THE BUILDING. IF THE EXISTING BACKFLOW IS NOT A DEDICATED IRRIGATION BACKFLOW, CONTRACTOR IS TO INSTALL A NEW BACKFLOW, SIZE ACCORDING TO METER SIZE.
- CONFIRM EXISTING CONTROLLER ZONE AVAILABILITY. IF CONTROLLER CANNOT HANDLE PROPOSED ZONES, CONTACT IRRIGATION DESIGNER IMMEDIATELY.
- CAP EXISTING LINES WHERE NECESSARY FOR CONSTRUCTION.
- MAINLINE APPROXIMATE LOCATION AS SHOWN. CONTRACTOR TO LOCATE EXACT LOCATION AND UTILIZE. PROTECT MAINLINE IN PLACE DURING CONSTRUCTION. CAP EXISTING MAINLINE AND LEAVE IN PLACE WHERE NECESSARY.
- DO NOT TRENCH UNDER EXISTING TREES. HAND TRENCH LATERALLY TO INSTALL HEADS, DRIP, ETC.
- ALL PROPOSED IRRIGATION TO MATCH EXISTING PRECIPITATION RATES. IF ZONES ARE COMBINED WITH EXISTING ZONES, NO DRIP AND HEADS TO BE ON SAME ZONES.
- ALL EXISTING IRRIGATION SHOWN TO REMAIN SHOULD BE PROTECTED DURING CONSTRUCTION. CONTRACTOR TO CONFIRM 100 PERCENT COVERAGE ON EXISTING AND MODIFY IF NEEDED.
- DO NOT REMOVE EXISTING SLEEVED LINES UNDER PAVEMENT UNLESS SPECIFIED.
- CONTRACTOR TO NUMBER EXISTING VALVES AND PROPOSED VALVES IN NUMERICAL ORDER STARTING FROM THE METER AND GOING IN A CLOCKWISE CIRCLE.


**IRRIGATION NOTES:**

- IRRIGATION CONTRACTOR SHALL TEST EXISTING STATIC PRESSURE ON SITE PRIOR TO CONSTRUCTION. SHOULD EXISTING SITE PRESSURE BE BELOW 65 PSI, CONTRACTOR SHALL CONTACT THE IRRIGATION DESIGNER PRIOR TO COMMENCEMENT OF CONSTRUCTION.
- COORDINATE IRRIGATION INSTALLATION WITH PLANTING PLAN AND SITE CONDITIONS TO PROVIDE COMPLETE 100% COVERAGE WITH MINIMUM OVERSPRAY. THE IRRIGATION CONTRACTOR SHALL MAKE MINOR ADJUSTMENTS TO ENSURE PROPER COVERAGE AT NO ADDITIONAL COST TO THE OWNER.
- ALL CONSTRUCTION SHALL CONFORM TO CITY, COUNTY, STATE, AND FEDERAL REQUIREMENTS. IT SHALL BE THE RESPONSIBILITY OF THE IRRIGATION CONTRACTOR TO ENSURE THAT ALL IRRIGATION EQUIPMENT MEETS GOVERNMENT REGULATIONS. CONTRACTOR SHALL ALSO BE RESPONSIBLE FOR OBTAINING ANY NECESSARY PERMITS OR APPROVALS PRIOR TO COMMENCEMENT OF OPERATIONS ON-SITE. COPIES OF THE PERMITS SHALL BE SENT TO THE OWNER/GENERAL CONTRACTOR.
- LATERAL PIPE SHALL BE INSTALLED AT A MINIMUM DEPTH OF 12 INCHES. MAINLINE PIPE AND WIRES SHALL BE INSTALLED AT A MINIMUM DEPTH OF 18 INCHES.
- ELECTRICAL POWER SHALL BE PROVIDED WITHIN 5 FEET OF CONTROLLER LOCATION BY GENERAL CONTRACTOR. LICENSED IRRIGATION CONTRACTOR TO PROVIDE FINAL HARD WIRE TO CONTROLLER.
- 24 VOLT VALVE WIRE SHALL BE A MINIMUM OF 14 GAUGE, U.L. APPROVED FOR DIRECT BURIAL, SINGLE CONDUCTOR "IRRIGATION WIRE". CONTRACTOR TO CONFIRM WIRE SIZE PRIOR TO INSTALLATION. WIRE SPLICES SHALL BE ENCASED IN A WATERPROOF WIRE CONNECTOR UL APPROVED AND FILLED WITH SILICONE.
- IRRIGATION VALVES AND VALVE BOXES SHALL BE LOCATED IN LANDSCAPE BEDS OR GROUND COVER AREAS WHENEVER POSSIBLE. ALL REMOTE VALVE BOXES SHALL BE SET FLUSH WITH FINISHED GRADE AND CONTAIN ONE CUBIC FOOT OF CLEAN GRAVEL BENEATH VALVE. LABEL REMOTE BOXES WITH ONE-INCH ALPHA NUMERIC NOTATION CORRESPONDING TO THE APPLICABLE ALPHA CONTROLLER AND NUMERIC STATION. USE 10" ROUND VALVE BOXES FOR ELECTRIC VALVES AND QUICK COUPLING VALVES. USE 15" X 9.5" RECTANGULAR BOX FOR DRIP VALVES UNLESS NOTED OTHERWISE. DOUBLE CHECK ASSEMBLY SHALL BE BOXED ACCORDING TO LOCAL CODES.
- USE PVC SWING JOINT ASSEMBLIES TO CONNECT ALL SPRAY AND ROTOR HEADS.
- CONTRACTOR IS TO CONTACT APPROPRIATE AUTHORITIES AND LOCATE ALL UTILITIES PRIOR TO CONSTRUCTION. CONTRACTOR SHALL VERIFY ALL DIMENSIONS, ELEVATIONS, EQUIPMENT QUANTITIES, AND UTILITY LOCATIONS PRIOR TO BEGINNING WORK.
- SLEEVES SHALL BE INSTALLED BY GENERAL CONTRACTOR UNLESS OTHERWISE NOTED. SLEEVE MATERIAL SHALL BE PVC, SCHD. 40. CONTRACTOR SHALL EXTEND SLEEVES 18 INCHES BEYOND EDGE OF ALL PAVEMENT. ELECTRICAL WIRES FOR IRRIGATION VALVES AND IRRIGATION LINES ARE TO BE PLACED IN SEPARATE SLEEVES. SEE SLEEVING DETAIL. ALL PRESSURE MAINLINES UNDER ASPHALT PAVEMENT SHALL BE PLACED WITHIN SLEEVES AS NOTED.
- DRIP LINE SHALL BE PLACED A MINIMUM OF 2" UNDER MULCH.
- LICENSED IRRIGATION CONTRACTOR SHALL ADJUST SPRAY NOZZLES FOR "HEAD-TO-HEAD" COVERAGE AND ADJUST FOR MINIMUM OVERSPRAY ONTO PAVEMENT. NO OVERSPRAY IS PERMITTED ONTO STREETS OR SIDEWALKS.
- IRRIGATION CONTRACTOR SHALL SUPPLY AND CONSTRUCT IRRIGATION SYSTEM WITH ALL MATERIALS AND PER MANUFACTURER SPECIFICATIONS SHOWN ON THIS PLAN. IF CONTRACTOR PREFERENCES MATERIALS THAT DIFFER FROM THE THIS PLAN, THEY SHALL BE APPROVED BY THE IRRIGATION DESIGNER PRIOR TO CONSTRUCTION.
- VERIFY CONTROLLER AND RAIN SENSOR LOCATION AND MAINLINE POINT OF CONNECTION AT PROJECT SITE WITH OWNER.
- EXISTING TREES TO REMAIN ARE TO BE PROTECTED FROM DAMAGE. DO NOT TRENCH OR EXCAVATE WITHIN THE CRITICAL ROOT ZONE OF ANY TREE.
- IRRIGATION LATERAL LINES, MAIN LINES AND EQUIPMENT MAY BE SHOWN OUTSIDE PROPERTY LINES ON THIS PLAN. ALL IRRIGATION LINES AND EQUIPMENT ARE TO BE WITHIN AND INSTALLED WITHIN THE LIMITS OF THE PROPERTY LINE.
- SUPPLY LINE AND METER TO BE PROVIDED BY GENERAL CONTRACTOR. BACKFLOW PREVENTER TO BE PROVIDED BY IRRIGATION CONTRACTOR. IRRIGATION CONTRACTOR'S POINT OF CONNECTION TO BEGIN AFTER THE IRRIGATION WATER METER.
- IRRIGATION CONTRACTOR SHALL REVIEW WINTERIZATION PROCEDURES FOR IRRIGATION SYSTEM WITH OWNERS REPRESENTATIVE.
- ALL PLANT MATERIAL IN TREE HOLDING AREAS SHALL BE MANUALLY WATERED/IRRIGATED TO KEEP MOIST UNTIL PLANTED.
- MAINLINE, VALVES, AND WIRING ARE SHOWN ON DRAWINGS FOR CLARITY. SHOULD BE LOCATED IN ACCESSIBLE GREEN SPACE. CONTRACTOR TO COORDINATE WITH ALL DISCIPLINES TO AVOID CONFLICTS WITH UTILITIES/ STRUCTURES, ETC.
- INSTALLATION OF WORK SHALL BE COORDINATED WITH OTHER CONTRACTORS IN SUCH A MANNER AS TO ALLOW FOR A SPEEDY AND ORDERLY COMPLETION OF ALL WORK ON THE SITE.
- CONTRACTOR SHALL PROVIDE "AS-BUILT" DRAWINGS OF THE FINAL INSTALLATION TO OWNER AT SUBSTANTIAL COMPLETION BEFORE RECEIVING FINAL PAYMENT. "AS-BUILT" DRAWINGS TO BE COLOR CODED BY ZONE ON 8.5" X 11", LAMINATED, AND PLACED IN CONTROLLER.
- ALL DRIP ZONES SHALL BE INSTALLED WITH A SELF-FLUSHING DISC FILTER, OR APPROVED EQUAL.
- INSTALL ALL IRRIGATION COMPONENTS AS PER MANUFACTURERS REQUIREMENTS.
- IRRIGATION HEADS AND COMPONENTS SHALL BE LOCATED A MINIMUM OF 24" FROM ALL BUILDINGS TO AVOID ADVERSE PERFORMANCE OF FOUNDATIONS AND SLABS.
- NO LATERALS LESS THAN 3/4" DIAMETER.

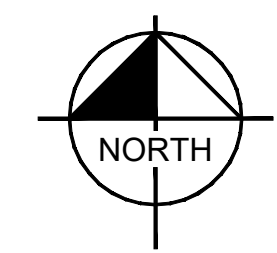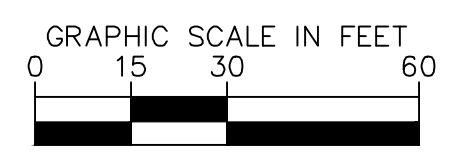

No.	REVISIONS	DATE	BY

**Kimley >>> Horn**  
 805 PENNSYLVANIA AVENUE, SUITE 150  
 KANSAS CITY, MO 64105  
 PHONE: 816-234-5000  
 WWW.KIMLEY-HORN.COM  
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 MO CERTIFICATE OF AUTHORITY #001512, EXPIRES 12/31/22

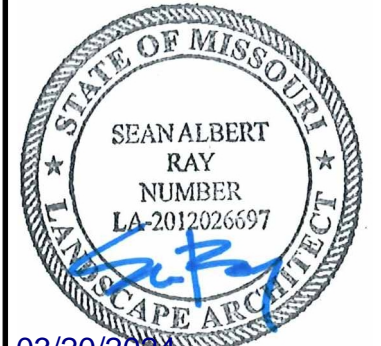

KHA PROJECT	268642000
DATE	03/20/2024
SCALE: AS SHOWN	DESIGNED BY: JOK
DRAWN BY: DLL	CHECKED BY: SAR


**IRRIGATION PLAN  
- BASE BID**

**CP241991  
FRANCIS QUADRANGLE  
IRRIGATION, DRAINAGE,  
AND TURF REPLACEMENT**

SHEET NUMBER  
**L-300**




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**IRRIGATION SCHEDULE**
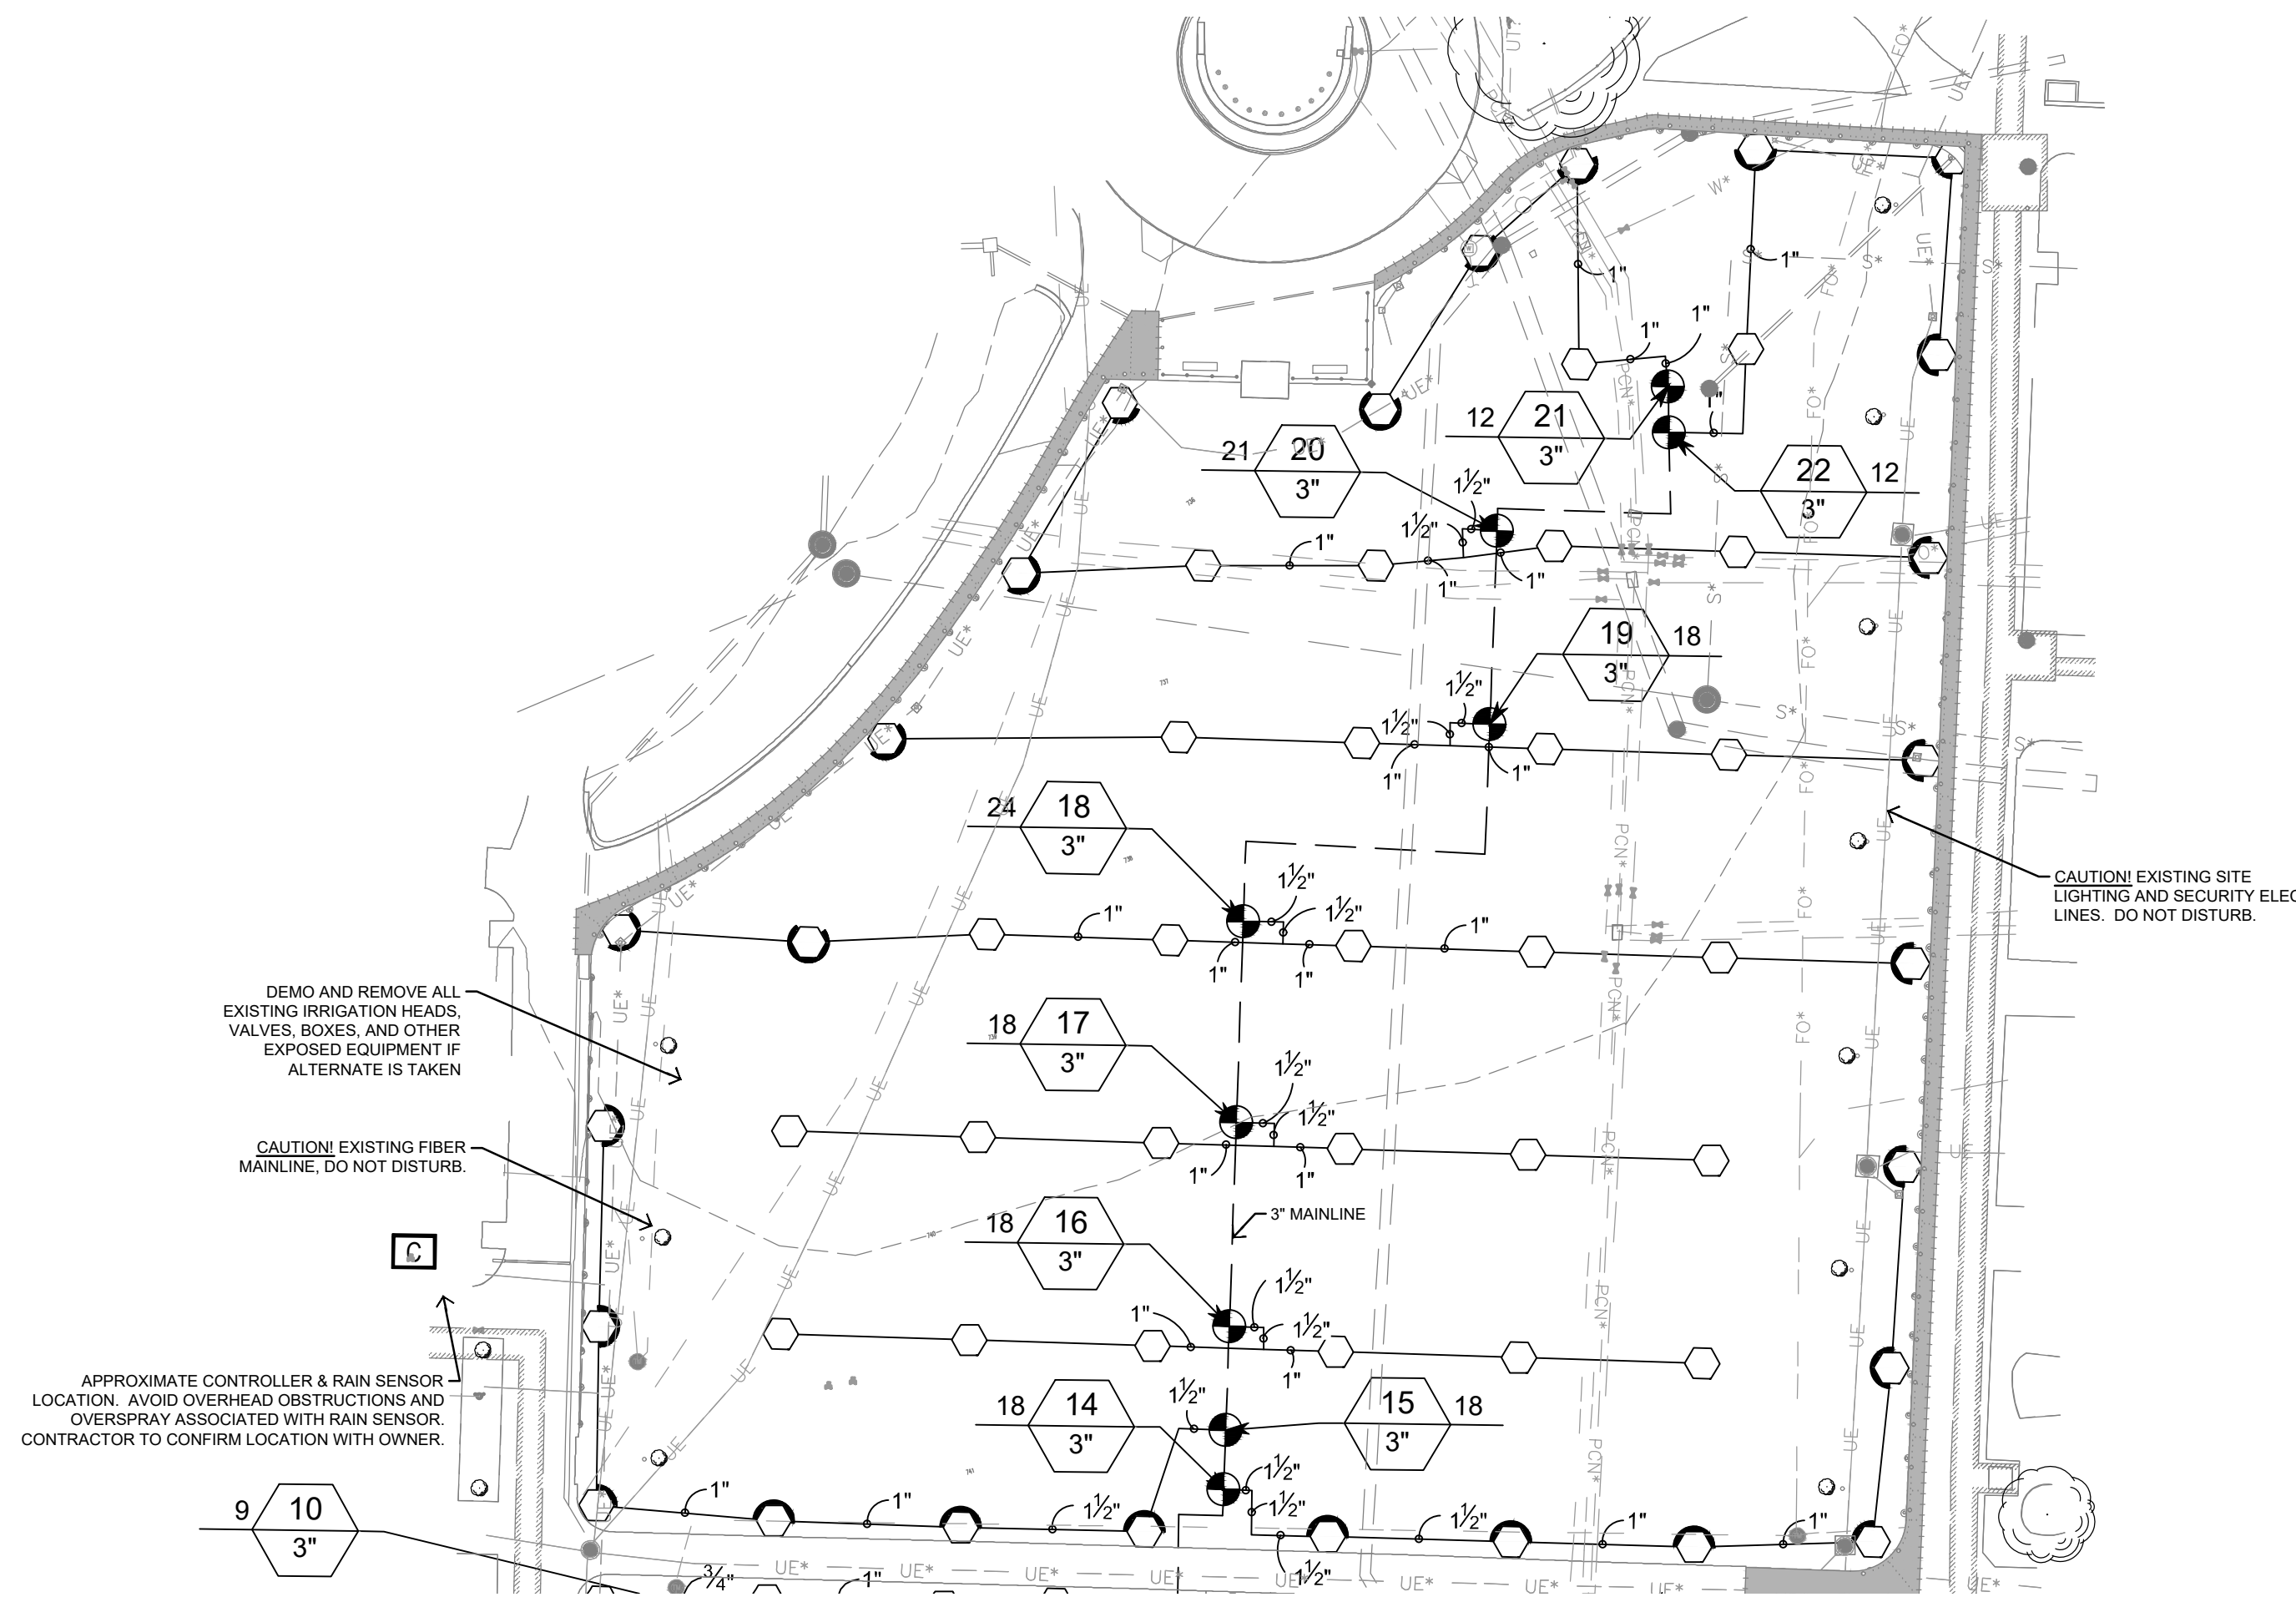
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(15)	HUNTER I-20-04 1.5 TURF ROTOR, 4IN. POP-UP, ADJUSTABLE AND FULL CIRCLE. PLASTIC RISER. DRAIN CHECK VALVE. STANDARD NOZZLE.	8
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(50)	HUNTER I-20-04 3.0 TURF ROTOR, 4IN. POP-UP, ADJUSTABLE AND FULL CIRCLE. PLASTIC RISER. DRAIN CHECK VALVE. STANDARD NOZZLE.	54
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SYMBOL	MANUFACTURER/MODEL/DESCRIPTION	QTY
(HV-FS)	HUNTER HV-FS 1IN., 1-1/2IN., 2IN., AND 3IN. BRASS ELECTRIC REMOTE CONTROL VALVE. GLOBE CONFIGURATION, WITH NPT THREADED INLET/OUTLET, FOR COMMERCIAL/MUNICIPAL USE. WITH FILTER SENTRY FACTORY INSTALLED OPTION.	22
(L-2)	LANDSCAPE PRODUCTS INC. BBV 1/2IN., 3/4IN., 1IN., 1-1/4IN., 1-1/2IN., 2IN., 2-1/2IN., 3IN. FULL PORT BRASS BALL VALVE. SUITABLE FOR A FULL RANGE OF LIQUIDS AND GASES IN RESIDENTIAL AND COMMERCIAL APPLICATIONS.	1
(MCV)	HUNTER BV 3 1IN., 1-1/2IN., 2IN., AND 3IN. BRASS ELECTRIC MASTER VALVE. GLOBE CONFIGURATION, WITH NPT THREADED INLET/OUTLET, FOR COMMERCIAL/MUNICIPAL USE.	1
(C)	HUNTER A2C-750-M 75-STATION DECODER CONTROLLER IN AN OUTDOOR GRAY METAL WALL MOUNT ENCLOSURE.	1
(POC)	POINT OF CONNECTION 3"	1
(---)	IRRIGATION LATERAL LINE: PVC SCHEDULE 40	4,531 L.F.
(---	IRRIGATION MAINLINE: PVC SCHEDULE 40	758.5 L.F.





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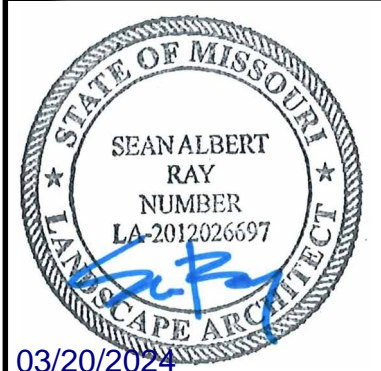
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- DRIP LINE SHALL BE PLACED A MINIMUM OF 2" UNDER MULCH.
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- IRRIGATION LATERAL LINES, MAIN LINES AND EQUIPMENT MAY BE SHOWN OUTSIDE PROPERTY LINES ON THIS PLAN. ALL IRRIGATION LINES AND EQUIPMENT ARE TO BE WITHIN AND INSTALLED WITHIN THE LIMITS OF THE PROPERTY LINE.
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- ALL DRIP ZONES SHALL BE INSTALLED WITH A SELF-FLUSHING DISC FILTER, OR APPROVED EQUAL.
- INSTALL ALL IRRIGATION COMPONENTS AS PER MANUFACTURERS REQUIREMENTS.
- IRRIGATION HEADS AND COMPONENTS SHALL BE LOCATED A MINIMUM OF 24" FROM ALL BUILDINGS TO AVOID ADVERSE PERFORMANCE OF FOUNDATIONS AND SLABS.
- NO LATERALS LESS THAN 3/4" DIAMETER.

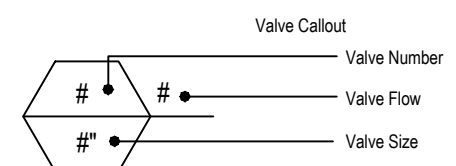

No.	REVISIONS	DATE	BY

**Kimley-Horn**  
 805 PENNSYLVANIA AVENUE, SUITE 150  
 KANSAS CITY, MO 64105  
 PHONE: 816-234-5000  
 WWW.KIMLEY-HORN.COM  
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KHA PROJECT	268642000
DATE	03/20/2024
SCALE:	AS SHOWN
DESIGNED BY:	JDK
DRAWN BY:	DLL
CHECKED BY:	SAR

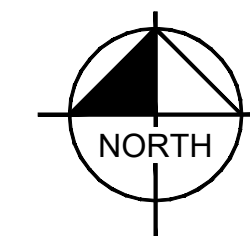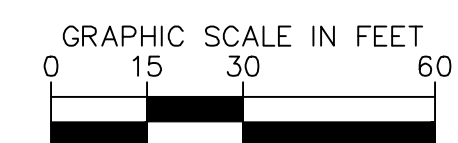
**IRRIGATION PLAN**  
**- ADD ALT #1**

**CP241991**  
**FRANCIS QUADRANGLE**  
 IRRIGATION, DRAINAGE,  
 AND TURF REPLACEMENT

SHEET NUMBER  
**L-301**




Drawing name: K:\KNC\_LA\268642000\_MU FRANCIS QUAD\2. DESIGN\CAD\PLANS\IRRI\IRRI\300 IRRIGATION.DWG Plot date: Friday, March 15, 2024 4:12:37 PM by: Lake, Debra Last saved: 3/15/2024 4:10 PM  
 This document, together with the concepts and designs presented herein, as an instrument of service, is intended only for the specific purpose and client for which it was prepared. Reuse of and improper reliance on this document without written authorization and adaptation by Kimley-Horn and Associates, Inc. shall be without liability to Kimley-Horn and Associates, Inc.

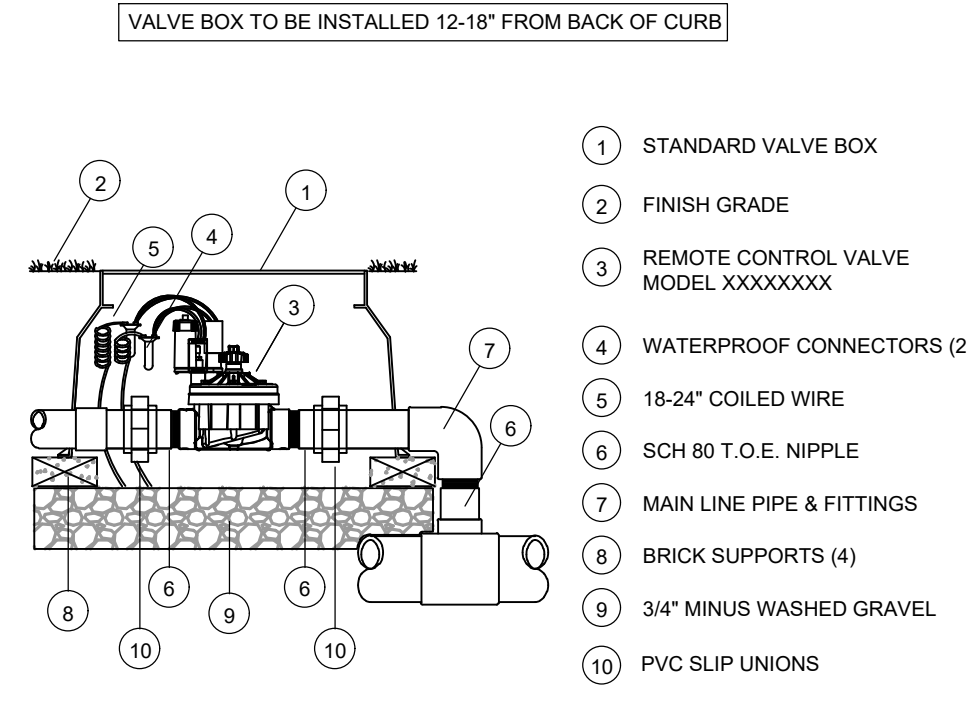

Electric Remote Control Valve

Scale: N.T.S.


D

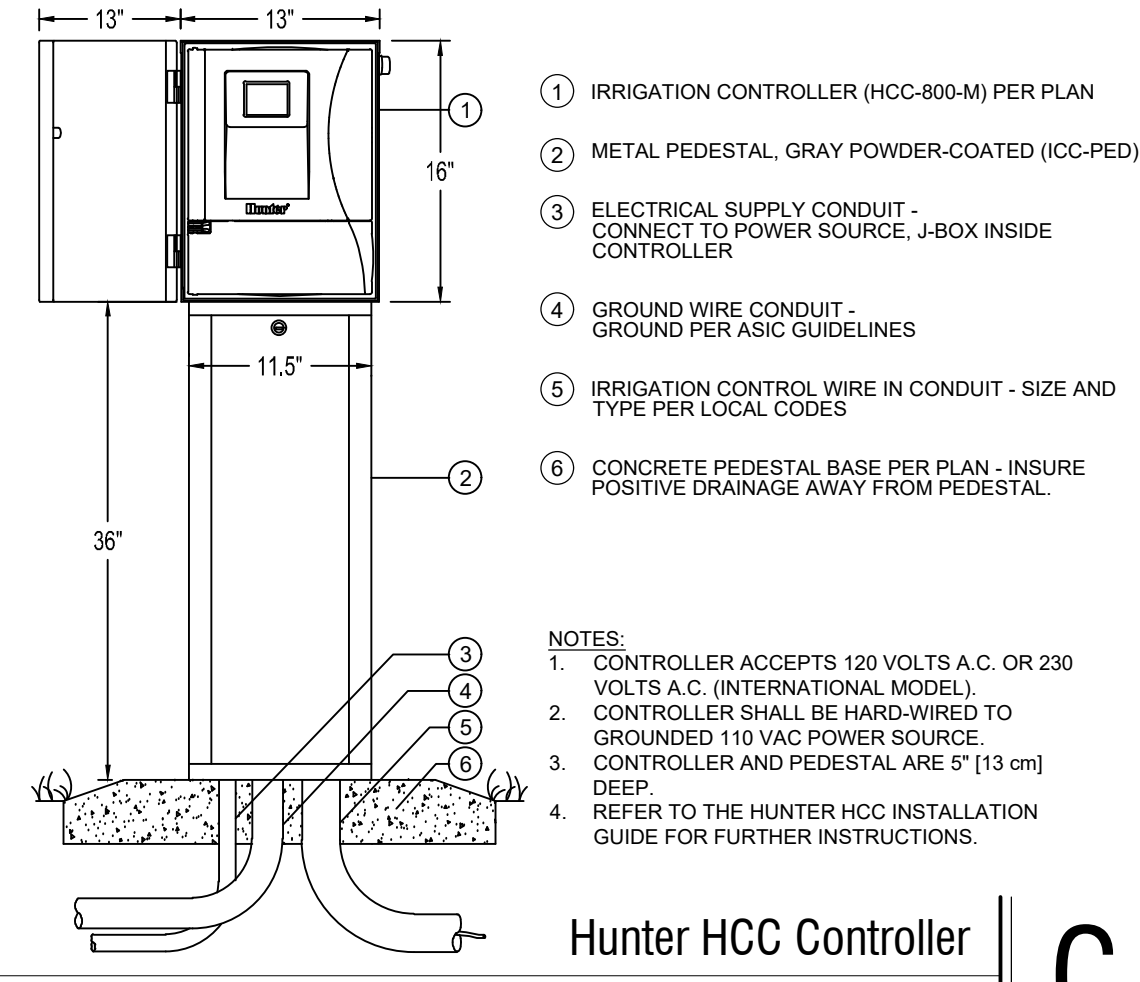

Hunter HCC Controller

Scale: N.T.S.


C

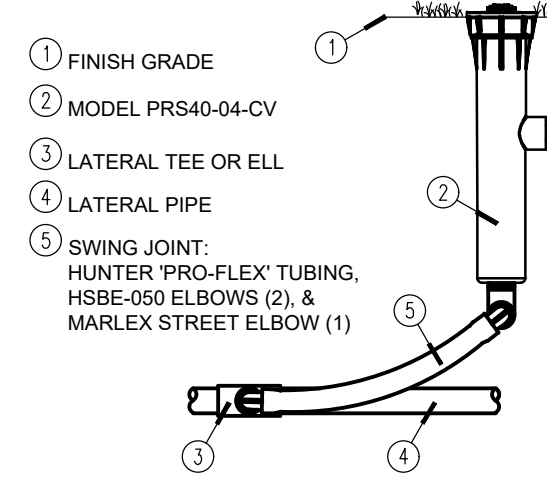

MP Rotator Sprinkler

Scale: N.T.S.

B

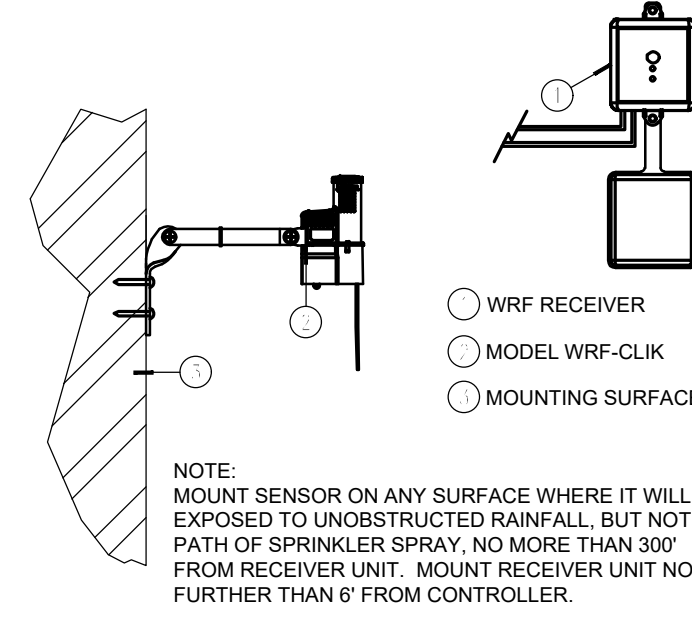


Wireless Rain/Freeze Sensor

Scale: N.T.S.

A

No.	REVISIONS	DATE	BY

**Kimley»Horn**  
 805 PENNSYLVANIA AVENUE, SUITE 150  
 KANSAS CITY, MO 64105  
 PHONE: 816-234-5000  
 WWW.KH.COM  
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KHA PROJECT	268642000
DATE	03/20/2024
SCALE: AS SHOWN	DESIGNED BY: JJK
DRAWN BY: DLL	CHECKED BY: SAR

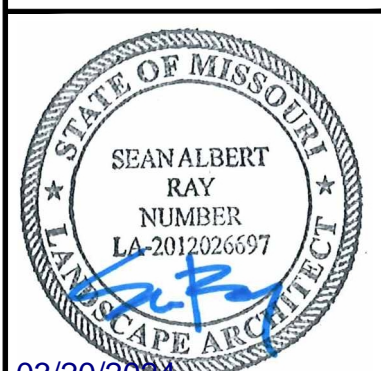**IRRIGATION  
DETAILS**

**CP241991  
FRANCIS QUADRANGLE  
IRRIGATION, DRAINAGE,  
AND TURF REPLACEMENT**

SHEET NUMBER  
**L-302**



